

# ARCHITECTURAL REVIEW BOARD MUNICIPAL PLANNING COMMISSION -AGENDA-

Thursday, September 14, 2023 at 7:00 P.M.

Louis J.R. Goorey Worthington Municipal Building The John P. Coleman Council Chamber 6550 North High Street Worthington, Ohio 43085

Watch online at worthington.org/live, and comment in person or at worthington.org/meeting-public-input

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# A. Call to Order - 7:00 pm

- 1. Roll Call
- 2. Pledge of Allegiance
- 3. Approval of minutes of the July 27, 2023 meeting
- 4. Affirmation/swearing in of witnesses.

# B. Architectural Review Board - Consent Agenda

There will be no separate discussion of Consent Agenda items as they are considered to be routine by the Board and Commission and will be adopted by one motion. If a member of the Board & Commission, staff, or public requests discussion on a particular item, that item will be removed from the Consent Agenda and considered separately on the agenda. Approval of Consent Agenda items includes conditions as listed in the staff memo.

- 1. New Roof & Paint Siding 171 E. Granville Rd. (Jake Rankey) ARB 62-2023
- 2. Roof-top Equipment **671 High St.** (Brian Swanson) **ARB 63-2023**
- 3. Exhaust Removal System **6500 N. High St.** (Kerry Stanforth/Worthington Fire and Emergency Medical Services) **ARB 65-2023**
- 4. Fence 38 E. New England Ave. (Michael Shadwick) ARB 70-2023

# C. Architectural Review Board – New Business

1. Signs – 940 High St. (Steve P. Moore/Anytime Fitness) ARB 60-2023

- 2. Addition 691-693 High St. (Jennifer M. Stevens/Kittie's Bakery & Cafe) ARB 61-2023
- 3. Replacement Windows **159-161 E. Granville Rd.** (Apco Industries/Silverman) **ARB 64-2023**
- 4. Sign 2151 W. Dublin-Granville Rd. (Great Impressions Signs/Rodos) ARB 66-2023
- 5. Addition 70 W. North St. (Steven Schwope/Gant) ARB 68-2023
- 6. Renovation & Additions 100 W. Granville Rd. (Element One/Turnock) ARB 69-2023
- 7. Window Replacement 111 W. North St. (Destany Todd/Baum) ARB 71-2023
- 8. Patio Furniture 53 W. Wilson Bridge Rd. (Jill Grosnoff/Huey Magoo's) ARB 72-2023

# D. Municipal Planning Commission – New Business

- 1. Amendment to Development Plan
  - a. Signage 6670 Huntley Rd. (Chris Tilton) ADP 09-2023

# E. Other

# F. Adjournment



#### **MEMORANDUM**

TO: Members of the Architectural Review Board

Members of the Municipal Planning Commission

FROM: Lynda Bitar, Planning Coordinator

DATE: September 8, 2023

SUBJECT: Staff Memo for the Meeting of September 14, 2023

# B. Architectural Review Board - Consent Agenda

There will be no separate discussion of Consent Agenda items as they are considered to be routine by the Board and Commission and will be adopted by one motion. If a member of the Board & Commission, staff, or public requests discussion on a particular item, that item will be removed from the Consent Agenda and considered separately on the agenda. Approval of Consent Agenda items includes conditions as listed in the staff memo.

1. New Roof & Paint Siding – 171 E. Granville Rd. (Jake Rankey) ARB 62-2023

# **Findings of Fact & Conclusions**

# **Background & Request:**

This one-story house was constructed in 1953, is 986 square feet in area, and sits on a lot that is about 66' wide and 344.825' deep. The applicant would like approval to replace the roof and will be painting the house.

# **Project Details:**

- 1. The existing roof consists of red three-tab shingles.
- 2. Proposed are black architectural shingles.
- 3. The plan involves painting the vinyl lap siding on the house Sherwin Williams "Grey Jacket", which is a navy-blue color. The trim would be repainted white.

# **Land Use Plans:**

# Worthington Design Guidelines and Architectural District Ordinance

When installing a new roof on a building that currently has asphalt shingles, avoid the uneven, "staggered-butt" design or other shingle patterns that try to create an older look; a medium gray color generally is appropriate on an older building if it originally had a slate roof. Green, red or black shingles may also be appropriate, depending on the building's predominant colors. Avoid very light-colored shingles.

The city has flexible policy giving building owners freedom in color selection but recommends avoiding colors inappropriate for Worthington's architecture. Compatibility of design and materials and exterior detail and relationships are standards of review in the Architectural District ordinance.

# **Recommendation:**

Staff is recommending *approval* of this application. The proposed roofing color and the color for the vinyl siding are appropriate.

#### **Motion:**

THAT THE REQUEST BY JAKE RANKEY FOR A CERTIFICATE OF APPROPRIATENESS TO INSTALL NEW ROOFING AT 171 E. GRANVILLE RD. AS PER CASE NO. ARB 62-2023, DRAWINGS NO. ARB 62-2023, DATED AUGUST 8, 2023, BE APPROVED BASED ON THE FINDINGS OF FACT AND CONCLUSIONS IN THE STAFF MEMO AND PRESENTED AT THE MEETING.

2. Roof-top Equipment – 671 High St. (Brian Swanson) ARB 63-2023

# **Findings of Fact & Conclusions**

# **Background & Request:**

This vernacular style commercial building was constructed in the 1800's, and additions/new construction occurred in the 1900's. In recent years, the 1<sup>st</sup> floor space was converted from retail to restaurant, and now houses the Worthington Tavern.

This is a request to install additional equipment on the roof.

# **Project Details:**

- 1. An HVAC unit with ductwork and a return air vent is proposed on the flat roof of the restaurant behind an existing screen fence.
- 2. The applicant claims there will be no view from ground level.

# **Land Use Plans:**

# Worthington Design Guidelines and Architectural District Ordinance

Compatibility of design and materials and exterior detail and relationships are important concepts in the Design Guidelines and standards of review in the Architectural District ordinance.

#### **Recommendation:**

Staff is recommending *approval* of this application as the equipment would be appropriately located.

#### **Motion:**

THAT THE REQUEST BY BRIAN SWANSON FOR A CERTIFICATE OF APPROPRIATENESS TO INSTALL ROOFTOP EQUIPMENT AT 671 HIGH ST., AS PER CASE NO. ARB 63-2023, DRAWINGS NO. ARB 63-2023, DATED AUGUST 9, 2023, BE APPROVED BASED ON THE FINDINGS OF FACT AND CONCLUSIONS IN THE STAFF MEMO AND PRESENTED AT THE MEETING.

3. Exhaust Removal System – **6500 N. High St.** (Kerry Stanforth/Worthington Fire and Emergency Medical Services) **ARB 65-2023** 

# **Findings of Fact & Conclusions**

# **Background & Request:**

The Worthington fire station building was constructed in the early 1990's. This is a request to add a vehicle exhaust removal system to the building.

# **Project Details:**

- 1. The MagneGrip system would be a long rail option source capture exhaust system that is mainly interior to the building with rails, ducts, and hoses that connect to the trucks.
- 2. Exhaust would be through a south facing rear building wall with a duct that would extend out and curve up to above the roof.
- 3. As the current documents do not meet the <u>2017 Ohio Building Code</u> requirements, the location off the duct may differ from that shown in the packet.

#### **Land Use Plans:**

Worthington Design Guidelines and Architectural District Ordinance

Compatibility of design and materials and exterior detail and relationships are important concepts in the Design Guidelines and standards of review in the Architectural District ordinance.

#### **Recommendation:**

Staff is recommending <u>approval</u> of this application regardless of the exact location of the exhaust duct as it will be on the rear of the building, and the system is needed for health reasons. If possible, the duct will be painted to blend with the building or trim.

#### **Motion:**

THAT THE REQUEST BY KERRY STANFORTH ON BEHALF OF THE CITY OF WORTHINGTON FOR A CERTIFICATE OF APPROPRIATENESS TO INSTALL AN EXHAUST REMOVAL SYSTEM DUCT AT 6500 N. HIGH ST., AS PER CASE NO. ARB 65-2023, DRAWINGS NO. ARB 65-2023, DATED AUGUST 16, 2023, BE APPROVED BASED ON THE FINDINGS OF FACT AND CONCLUSIONS IN THE STAFF MEMO AND PRESENTED AT THE MEETING.

4. Fence – **38 E. New England Ave.** (Michael Shadwick) **ARB 70-2023** 

# **Findings of Fact & Conclusions**

# **Background & Request:**

A contributing building in the Worthington Historic District, this 1910 house is described in the nomination as a cottage style home, but it also has characteristics of a Craftsman structure. The house has a main gable with gabled dormers on the east and west sides, and a porch that wraps around the front to the west side of the structure. The structure started as a single-family home, but was converted to accommodate two and three families at different times in the twentieth century. In the 2000's, it was changed back to a single-family structure.

This property is located in the AR-4.5 and R-10 Zoning Districts on the north side of E. New England Ave. An easement and drive aisle are in place on the west side of the lot to allow access to the parking lot behind several High St. commercial properties. A City parking lot is adjacent to the west.

There is a concrete patio on the west side of the house and the owner would like to screen it with a fence.

# **Project Details:**

- 1. The fence is planned to connect to the corner of the front porch; extend west and along the patio for 44'; and return to the back of the house for 15' which would include a 36" wide gate. The fence is proposed to be 12" from the asphalt drive.
- 2. The fence would be cedar and designed to match the fencing used at the lodge PUD, which is 6' high with solid boards at the bottom and open pickets at the top.

# **Land Use Plans:**

# Worthington Design Guidelines and Architectural District Ordinance

Side yard fences should be open in style (avoid solid, opaque fences that block all views) and three to four feet in height. In the back yard, generally avoid fences over four feet in height; higher fences are discouraged but may be appropriate where a commercial use abuts a residential property. In all cases, no fences higher than six feet are permitted.

#### **Recommendations:**

Staff is recommending *approval* of this application as the fence is adjacent to a commercial drive, matches the fencing on the south side of E. New England Ave., and is complementary to the house.

#### **Motion:**

THAT THE REQUEST BY MICHAEL SHADWICK FOR A CERTIFICATE OF APPROPRIATENESS TO ADD FENCING AT 38 E. NEW ENGLAND AVE., AS PER CASE NO. ARB 70-2023, DRAWINGS NO. ARB 70-2023, DATED AUGUST 28, 2023, BE APPROVED BASED ON THE FINDINGS OF FACT AND CONCLUSIONS IN THE STAFF MEMO AND PRESENTED AT THE MEETING.

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#### C. Architectural Review Board – New Business

1. Signs – 940 High St. (Steve P. Moore/Anytime Fitness) ARB 60-2023

# **Findings of Fact & Conclusions**

# **Background & Request:**

This building was constructed in 1962 and housed a pharmacy (CVS, Revco) on the south end and FedEx/Kinko's on the north end for many years. Ace Hardware moved into the southern space in 2012 and FedEx moved out of the northern space in 2021.

Anytime Fitness plans to move into the northern space and would like approval for sign installation.

# **Project Details:**

- 1. New panels are proposed for the bottom half of the freestanding sign that would be 92 ½" wide x 29 5/8" high or 19.03 square feet (sf) per panel and 38.1 sf total. The background is shown as white with black vinyl letters, a purple logo, and a tag line reading "Training Nutrition Recovery" in white with a black background. With the Ace portion of the sign, it appears there are 5 styles and 5 sizes of lettering (the logo is included). A variance granted on January 5, 2006 allowed this sign to have 4 styles of lettering and 4 sizes of lettering. Modification of the sign design or an additional allowance by way of a variance is needed.
- 2. Internally illuminated white channel letters, a purple logo, and a black box with push-thru white letters with the tag line are proposed on the face above the storefront. The area of the sign is 334 7/8" x 42 7/16" = 98.7 square feet. The main letters would be 15 15/16" high and the logo would be 42 7/16" high.
- 3. Total area for the Anytime Fitness signage is proposed as 38.1 sf + 98.7 sf = 136.8 sf which exceeds the allowable 100 sf per business. Reduction in size or a variance would be needed.

#### **Land Use Plans:**

# Worthington Design Guidelines and Architectural District Ordinance

While the regulations permit a certain maximum square footage of signs for a business, try to minimize the size and number of signs. Place only basic names and graphics on signs along the street so that drive-by traffic is not bombarded with too much information. Free-standing signs should be of the "monument" type; they should be as low as possible. Such signs should have an appropriate base such as a brick planting area with appropriate landscaping. Colors for signs should be chosen for compatibility with the age, architecture, and colors of the buildings they serve, whether placed on the ground or mounted on the building.

# Worthington Code Sections:

# 1170.03 Design Requirements.

(b) <u>Illumination</u>. Internally illuminated signs shall be constructed so as to allow the illumination of only letters, numbers or other identifying symbols on the display surface. No light shall pass through the background.

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# 1170.04 Measurement.

(a) Sign area is calculated by totaling all display areas of a sign, including sign faces, molding and framing, but excluding supporting members less than or equal to twenty-four inches in width.

# 1170.05 Commercial and Industrial District Requirements.

(a) <u>Sign area</u>. Allowable permanent sign area for any single business shall be limited according to the widths of the building or part of the building occupied by such enterprise. For the purposes of this section, width shall be measured along the building face nearest parallel to the street line. In the case of a corner lot, either frontage may be used in determining maximum area for signage. The area of all permanent signs for any single business shall be equivalent to one and one-half square feet of sign area for each lineal foot of width of the building or part of the building, but shall not exceed a maximum area of 100 square feet per business.

# **Recommendations:**

- The tag line should be removed from the freestanding sign panels to simplify the sign.
- Reduction in the size of the wall sign would be an appropriate way to deal with the overage in total sign area and more closely blend with the Ace Hardware sign.

#### **Motion:**

THAT THE REQUEST BY STEVE P. MOORE ON BEHALF OF ANYTIME FITNESS FOR A CERTIFICATE OF APPROPRIATENESS TO INSTALL NEW SIGNAGE AT 940 HIGH ST. AS PER CASE NO. ARB 60-2023, DRAWINGS NO. ARB 60-2023, DATED JULY 25, 2023, BE APPROVED BASED ON THE FINDINGS OF FACT AND CONCLUSIONS IN THE STAFF MEMO AND PRESENTED AT THE MEETING.

2. Addition – 691-693 High St. (Jennifer M. Stevens/Kittie's Bakery & Cafe) ARB 61-2023

# **Findings of Fact & Conclusions**

# **Background & Request:**

Kittie's Handcrafted Baked Goods & Café has taken over the Highline Coffee Co. space, which is 607 sf on the first floor of the twentieth century commercial building at the southwest Village Green. The business occupies the northern two storefronts, but only makes use of the door at the main storefront to the north. In addition to the seating inside, the previous owner added two 24 ¾" square tables with 2 chairs each outside of the shop in 2016.

This is a request for new signage.

# **Project Details:**

1. A wall sign consisting of 15" high individual letters that are white mounted on blue backgrounds is proposed above the main entrance. The sign is shown as 90" wide x 15" high for 9.4 sf of sign area. Construction would be of wood or material to look like wood.

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- 2. A projection sign would be installed on a bracket south of the main storefront. The 2" thick round sign is proposed to be 22" in diameter; have a routed border; and a "K" in the middle made with two layers of material. The colors include: PMS 3035 (dark shade of cyan background); PMS 199 (Pink-red edge of circle and shadow of "K"); light blue (accent on sides and face of "K"; and white ("K" and border). The bottom of the sign is proposed 100" above sidewalk grade.
- 3. Window signs are proposed inside the storefront glass of both spaces, including facing the Village Green to the north. For the smaller storefront to the south where people do not enter from the outside, lettering and banners that cover about half of the windows is proposed. People could see into the space through the white lettering on the front. The pink-red banners on the side windows would be opaque.

# **Land Use Plans:**

# Worthington Design Guidelines and Architectural District Ordinance

Guideline recommendations for signage include being efficient in using signs. Try to use as few and as small signs as are necessary to get the business message across to the public. Colors for signs should be chosen for compatibility with the age, architecture, and colors of the buildings they serve. Signs must be distinctive enough to be readily visible but avoid incompatible modern colors. Signage, including the appropriateness of signage to the building, is a standard of review per the Architectural District ordinance.

# Worthington Code Sections:

# 1170.02 Definitions and Provisions

(i) "Internal sign" means an indoor sign viewed through windows from the exterior. Internal signs shall not occupy more than twenty-five (25%) of the window area contiguous to the sign and shall not be illuminated. Internal signs are excluded in the computation of sign area.

# **Staff Comments:**

Due to a need for variances for the internal signs on the southern storefront, it would be helpful for the ARB to discuss the appropriateness of the signs.

#### **Recommendation:**

Staff is recommending <u>approval</u> of this application. The proposed permanent signs meet the guidelines for size and compatibility.

# **Motion:**

THAT THE REQUEST BY JENNIFER M. STEVENS ON BEHALF OF DIANE HERMAN FOR A CERTIFICATE OF APPROPRIATENESS TO INSTALL NEW SIGNS AT 691-693 HIGH ST. AS PER CASE NO. ARB 61-2023, DRAWINGS NO. ARB 61-2023, DATED JULY 31, 2023, BE APPROVED BASED ON THE FINDINGS OF FACT AND CONCLUSIONS IN THE STAFF MEMO AND PRESENTED AT THE MEETING.

3. Replacement Windows – **159-161 E. Granville Rd.** (Apco Industries/Silverman) **ARB 64-2023** 

# **Findings of Fact & Conclusions**

# **Background & Request:**

This brick Prairie style duplex was built in 1921 and is in the R-10 Zoning District. Approval was received in 2020 to construct an addition and new garages on the property and the work was completed in 2022.

This request is to allow the windows to be replaced.

# **Project Details:**

- 1. The existing windows are the original wood windows and storm windows are in place in most cases.
- 2. The proposed replacement windows are Plygem 2000 vinyl windows. The white windows would be installed inside the existing frames. New grids are planned that would be between the glass panes. Windows listed as sliders would instead be picture windows. It is not clear if that means they would be fixed and not able to open.

#### Land Use Plan:

# Worthington Design Guidelines and Architectural District Ordinance

Retention and repair of existing historic windows is always preferable to replacement. Because they usually comprise so much of a building's exterior surface, windows are a major part of its character. Keeping them is one of the most important ways to protect that character. Even non-original windows may be of sufficient age and design quality to warrant their retention.

If energy efficiency is a concern, interior or exterior storm windows can greatly increase the insulating quality of windows. Some interior storm windows are held in place by magnetic strips and are easy to remove for cleaning and maintenance; many exterior storm windows slide in tracks and include screens so windows can be opened in warm weather. In some thicker window sash it may be possible to re-glaze with insulated panes -- but avoid removing historic "wavy" glass to do so; use storm windows instead. If these measures do not provide adequate energy efficiency, new replacement windows may be appropriate.

If historic windows are too deteriorated to repair cost effectively and replacement is justified, the preferred option is an in-kind replacement in the same material and design. This usually means real wood windows with true through-the glass muntins (if appropriate) in dimensions and profiles that duplicate the originals. Window suppliers have become very good at doing such work at reasonable prices, but this still may take some persistence and hunting around.

New windows made of substitute materials such as aluminum, vinyl, or clad wood can be an acceptable second choice if they provide a reasonably good match for the windows being replaced. Number of panes, real muntins, and correct profiles still are important. Avoid enlarging or

downsizing window openings to accommodate stock sizes of replacements. Also avoid permanent blocking in of windows; the original window pattern of a house is part of its overall design.

# **Staff Comments:**

- 1. Retention and repair of original wood windows is preferrable.
- 2. It is not clear from the measurements listed that the window sizes are not changing.
- 3. Grids between the panes will not look the same as the existing windows. Simulated divided light with grids on the inside, outside and between the panes would provide a better match.

# **Recommendation:**

Staff is recommending that if the wood windows cannot be restored, they be replaced with windows that give the same look as the existing.

#### **Motion:**

THAT THE REQUEST BY ANDREW SILVERMAN FOR A CERTIFICATE OF APPROPRIATENESS TO REPLACE THE WINDOWS AT 159-161 E. GRANVILLE RD. AS PER CASE NO. ARB 64-2023, DRAWINGS NO. ARB 64-2023, DATED AUGUST 16, 2023, BE APPROVED BASED ON THE FINDINGS OF FACT AND CONCLUSIONS IN THE STAFF MEMO AND PRESENTED AT THE MEETING.

4. Sign – 2151 W. Dublin-Granville Rd. (Great Impressions Signs/Rodos) ARB 66-2023

# **Findings of Fact & Conclusions**

# **Background & Request:**

This shopping center was originally constructed in the 1950's, with a major addition and renovation completed in the late 1980's. At that time, the storefronts and signs were approved in a uniform manner. Over the years, many amendments have been approved including the addition of a gable at the east end, multiple sign changes and most recently a change to the color scheme. In 2008, the eastern half of the building was approved for a facelift including new fascia and a change to the sign styles.

This request would allow installation of a new sign for Rodos Greek Taverna.

# **Project Details:**

- 1. The new sign would be above the storefront, centered below two existing gooseneck lamps (it is shown incorrectly in the photo).
- 2. The proposed sign would be 11'4" wide by 30" high or 28.3 sf of sign area with a black background and white lettering.
- 3. A routed oval shaped 60" wide logo is proposed to the left and "RESTAURANT" "BAR" PVC letters would be to the right.

#### **Land Use Plans:**

# Worthington Design Guidelines and Architectural District Ordinance

While the regulations permit a certain maximum square footage of signs for a business, try to minimize the size and number of signs. Colors for signs should be chosen for compatibility with the age, architecture and colors of the buildings they serve, whether placed on the ground or mounted on the building.

#### **Recommendations:**

Staff is recommending <u>approval</u> of this application, as the proposed sign is appropriate in this location.

# **Motion:**

THAT THE REQUEST BY GREAT IMPRESSIONS SIGNS FOR A CERTIFICATE OF APPROPRIATENESS TO INSTALL A SIGN FOR RODOS GREEK TAVERNA AT 2151 W. DUBLIN-GRANVILLE RD., AS PER CASE NO. ARB 66-2023, DRAWINGS NO. ARB 66-2023, DATED AUGUST 22, 2023, BE APPROVED BASED ON THE FINDINGS OF FACT AND CONCLUSIONS IN THE STAFF MEMO AND PRESENTED AT THE MEETING.

5. Addition – 70 W. North St. (Steven Schwope/Gant) ARB 68-2023

# **Findings of fact & Conclusions**

# **Background & Request:**

This house was built in 1933 and is on a property that includes two 50' wide lots that are both 412.9' deep and in the R-10 Low Density Residence Zoning District. The house is a contributing building in the Worthington Historic District and listed as Colonial Revival Influence in style. It spans the width of the eastern 50' lot, sitting about 30' from the front property line. A two-car freestanding garage is on the west side and lines up with the back of the house. The entire property has been landscaped, including rock features and art, and is well maintained by the property owners.

This is a request to construct a one-story addition on the back of the house to allow the owners to create an accessible space.

# **Project Details:**

- 1. The addition is proposed to be 14'4" wide x 12'8" deep and aligned with the east side of the existing house.
- 2. The Board of Zoning Appeals approved a variance to allow the addition to be 4'11" from the east property line. The exterior wall would require a minimum 1 hour, fire-resistance-rated assembly per RCO 302.1.
- 3. An existing bathroom and bedroom would be converted into a laundry room, accessible bathroom and hallway leading to the addition, which would be the new bedroom.

ARB-MPC Staff Memo Meeting September 14, 2023 Page 10 of 18 4. Materials would match the existing house including painted wood lap siding and reuse of a window.

#### **Land Use Plans:**

# Worthington Design Guidelines and Architectural District Ordinance

Residential additions are recommended to maintain similar roof forms; be constructed as far to the rear and sides of the existing residence as possible; be subordinate; and have walls set back from the corners of the main house. Be sure that window designs are appropriate for the style or time period of the house.

#### **Recommendation:**

Staff is recommending <u>approval</u> of this application. Although the outside wall is not set back, the proposed structure is to the rear, subordinate and the design matches the existing house.

#### **Motion:**

THAT THE REQUEST BY STEVEN SCHWOPE ON BEHALF OF NEIL GANT FOR APPROVAL TO CONSTRUCT A REAR ADDITION AT 70 W. NORTH ST., AS PER CASE NO. VAR 30-2023, DRAWINGS NO. VAR 30-2023, DATED AUGUST 10, 2023, BE APPROVED BASED ON THE FINDINGS OF FACT AND CONCLUSIONS IN THE STAFF MEMO AND PRESENTED AT THE MEETING.

6. Renovation & Additions – 100 W. Granville Rd. (Element One/Turnock) ARB 69-2023

# **Findings of fact & Conclusions**

# **Background & Request:**

This house is a two-story colonial revival style that was built originally in 1921 and is a contributing building in the Worthington Historic District. The applicant would like to modify the existing house and construct several additions.

# **Project Details:**

- 1. Renovation:
  - a. Roof The original front part of the house would retain the existing slate shingles. Three chimneys in the original part of the house are planned to be saved remain. The previous one-story rear addition is planned to get a second floor so that chimney and roof would be removed.
  - b. Siding The house is currently sided with a light blue vinyl siding. That will be replaced with Hardi lap siding in white.
  - c. Windows The existing windows in the house are decorative with muntins in the top half that form narrow panes of glass with diamond shapes at the top. The applicant says the weights do not work and the windows have been painted shut. Proposed windows would be Trimline clad wood windows in a 6 over 1 pattern for the double hungs, and fixed 6 and 8 panes.
  - d. Four glass doors are proposed along the rear wall to provide access to the deck.

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- e. New garage doors are proposed that would have horizontal windows over vertical panels in the front and over square panels in the rear.
- f. Dentils and fascia on the original house would remain.

#### 2. Additions:

- a. Front Porch A new front porch is proposed that would be faced with Beldin Brick Belcrest 760. A hipped roof with bronze standing seam metal would be supported in the front of the porch by 2 fiberglass columns at each corner. A photo was included from 1921 showing a front porch with a shallow roof and a wood landing and steps.
- b. Rear 2<sup>nd</sup> Story A second story is proposed above an existing one-story addition to the rear. The flat roof part of the hip in the original part of the house would continue to the rear above this addition. Dentils and fascia would continue on the addition to match the original house. A new bedroom suite is proposed in this addition.
- c. Mudroom Addition This addition between the house and garage would be  $6'10 \frac{1}{2}$ " x 13' 65/16". The connection of the dwelling to the garage will require separation in the form of gypsum drywall per RCO 302.6 and a carbon monoxide alarm outside sleeping area per RCO 315.
- d. Materials The same Hardi lap siding and windows proposed for the front of the house would be used, except rear windows would be black. Two windows that are wide and shallow are shown on the sides. New roofing would be Certainteed Landmark Pro Colonial Slate. A chandelier type fixture is shown on the front porch ceiling, and wall lanterns would be next to the rear doors.

# 3. Rear Deck and Patio:

- a. A new rear deck, 19'5" x 16'4", is proposed to replace the existing deck. It would be made of Trex decking in Tigerwood with black RadianceRail around the outside and down the steps.
- b. A new stamped concrete patio is proposed. One of the perspectives shows planter boxes clarification is needed.

#### **Land Use Plans:**

# Worthington Design Guidelines and Architectural District Ordinance

- Residential additions are recommended to maintain similar roof forms; be constructed as far to the rear and sides of the existing residence as possible; be subordinate; and have walls set back from the corners of the main house. Design and materials should be traditional, and compatible with the existing structure.
- Siding: Existing historic wood siding should be retained and repaired as required. Such siding gives historic buildings a texture and appearance important to their character. Most siding is painted to weatherproof it, and keeping the paint in good shape is very important. If paint consistently blisters or peels off wood siding, look for moisture coming from leaking gutters or downspouts; leaking supply or drainpipes on the interior; wall insulation that has collected moisture; or ground moisture rising into the siding. Correct these conditions and dry out the siding before painting again. Repairs to damaged siding should be done with new wood that exactly matches the appearance of the existing. Historic wood siding should not be covered over or removed if it is repairable. Contemporary materials that simulate traditional ones are appropriate, but the preferred option is to use true traditional materials such as wood siding.
- Roof: Repair and retain existing traditional roofs such as wood shingle or slate. Roof materials

often were intended to add to a building's character (especially slate) and should be retained for that reason.

- Porch: New porches (located where one is missing or there has not been a porch in the past) should be built in a simple, contemporary design. Look at original porches on similar buildings -- height, materials, roof slope, width -- and use these to develop a design. Avoid ornamentation such as spindles and scrollwork unless they were traditionally used on the porches of similar buildings. Be sure that a new porch is large enough to accommodate furniture, swings, or other elements.
- Windows: Retention and repair of existing historic windows is always preferable to replacement. Because they usually comprise so much of a building's exterior surface, windows are a major part of its character. Keeping them is one of the most important ways to protect that character. If historic windows are too deteriorated to repair cost effectively and replacement is justified, the preferred option is an in-kind replacement in the same material and design. This usually means real wood windows with true through-the glass muntins (if appropriate) in dimensions and profiles that duplicate the originals. Window suppliers have become very good at doing such work at reasonable prices, but this still may take some persistence and hunting around.

New windows made of substitute materials such as aluminum, vinyl, or clad wood can be an acceptable second choice if they provide a reasonably good match for the windows being replaced. Number of panes, real muntins, and correct profiles still are important. Avoid enlarging or downsizing window openings to accommodate stock sizes of replacements. Also avoid permanent blocking in of windows; the original window pattern of a house is part of its overall design.

# **Staff Comments:**

- 1. The proposed windows would change the character of the house, as the existing are unique.
- 2. The new front porch may be more appropriate if the roof form and materials matched the porch constructed in 1921. Also, railings will be needed for the stairs.
- 3. The proportions of the wide, shallow windows on the sides should be modified to more closely resemble the rest of the windows in the house.
- 4. It seems unusual to have different colored windows on the rear elevations.
- 5. The garage doors with the horizontally oriented windows at the top are uncommon.
- 6. Replacement of the siding would be an improvement, especially if the width resembles the original siding on the house.

#### **Recommendation:**

Staff recommends *approval* of this application with consideration of the comments above.

# **Motion:**

THAT THE REQUEST BY ELEMENT ONE ON BEHALF OF THE TURNOCKS FOR A CERTIFICATE OF APPROPRIATENESS TO RENOVATE AND ADD ONTO THE HOUSE AT 100 W. GRANVILLE RD. AS PER CASE NO. ARB 69-2023, DRAWINGS NO. ARB 69-2023, DATED AUGUST 28, 2023, BE APPROVED BASED ON THE FINDINGS

# OF FACT AND CONCLUSIONS IN THE STAFF MEMO AND PRESENTED AT THE MEETING.

7. Window Replacement – 111 W. North St. (Destany Todd/Baum) ARB 71-2023

# **Findings of Fact & Conclusions**

# **Background & Request:**

This house, constructed in 1940, is of Colonial Revival influence and a contributing building in the Worthington Historic District.

This request is to allow the windows to be replaced.

# **Project Details:**

- 1. The existing windows are the original wood windows and have storm windows on the outside.
- 2. The proposed replacement windows are Fibrex composite material and would be installed in the same locations with the same size as the existing. Double hung windows are proposed and the muntins would be interior only.

# **Land Use Plan:**

# Worthington Design Guidelines and Architectural District Ordinance

Retention and repair of existing historic windows is always preferable to replacement. Because they usually comprise so much of a building's exterior surface, windows are a major part of its character. Keeping them is one of the most important ways to protect that character. Even non-original windows may be of sufficient age and design quality to warrant their retention.

If energy efficiency is a concern, interior or exterior storm windows can greatly increase the insulating quality of windows. Some interior storm windows are held in place by magnetic strips and are easy to remove for cleaning and maintenance; many exterior storm windows slide in tracks and include screens so windows can be opened in warm weather. In some thicker window sash it may be possible to re-glaze with insulated panes -- but avoid removing historic "wavy" glass to do so; use storm windows instead. If these measures do not provide adequate energy efficiency, new replacement windows may be appropriate.

If historic windows are too deteriorated to repair cost effectively and replacement is justified, the preferred option is an in-kind replacement in the same material and design. This usually means real wood windows with true through-the glass muntins (if appropriate) in dimensions and profiles that duplicate the originals. Window suppliers have become very good at doing such work at reasonable prices, but this still may take some persistence and hunting around.

New windows made of substitute materials such as aluminum, vinyl, or clad wood can be an acceptable second choice if they provide a reasonably good match for the windows being replaced. Number of panes, real muntins, and correct profiles still are important. Avoid enlarging or

ARB-MPC Staff Memo Meeting September 14, 2023 Page 14 of 18 downsizing window openings to accommodate stock sizes of replacements. Also avoid permanent blocking in of windows; the original window pattern of a house is part of its overall design.

# **Staff Comments:**

- 1. Retention and repair of original wood windows is preferrable.
- 2. Interior grids will not look the same as the existing windows. Simulated divided light with grids on the inside, outside and between the panes would provide a better match.

#### **Recommendation:**

Staff is recommending that if the wood windows cannot be restored, they be replaced with windows that give the same look as the existing.

#### **Motion:**

THAT THE REQUEST BY DESTANY TODD ON BEHALF OF MARGARET BAUM FOR A CERTIFICATE OF APPROPRIATENESS TO REPLACE THE WINDOWS AT 111 W. NORTH ST. AS PER CASE NO. ARB 71-2023, DRAWINGS NO. ARB 71-2023, DATED AUGUST 29, 2023, BE APPROVED BASED ON THE FINDINGS OF FACT AND CONCLUSIONS IN THE STAFF MEMO AND PRESENTED AT THE MEETING.

8. Patio Furniture – **53 W. Wilson Bridge Rd.** (Jill Grosnoff/Huey Magoo's) **ARB 72-2023** 

# **Findings of Fact & Conclusions**

# **Background & Request:**

This multi-tenant building is part of the Worthington Gateway Planned Use District (PUD) and is the easternmost building along W. Wilson Bridge Rd. As part of the previous approvals, areas were designated as patio areas for restaurants.

This is a request to add patio furniture for Huey Magoo's on the east side of the building.

# **Project Details:**

- 1. Disregard the signage and blackout film shown in the elevation.
- 2. Six rectangular tables are proposed for the patio which would east seat four people. Five black umbrellas are shown. No signage would be allowed on the umbrellas.
- 3. The tables would be constructed with black metal frames and wood look tops.
- 4. Chairs are proposed to be red metal.
- 5. A railing is proposed around the perimeter of the patio that does not match the same design used elsewhere on the site: black aluminum picket with circles at the top. The railing shown does not have circles at the tops.

# **Land Use Plans:**

# Worthington Design Guidelines and Architectural District Ordinance

The Design Guidelines recognize seating and tables for use by patrons makes an area feel more open and pedestrian-friendly. The Architectural District Ordinance calls for design and materials to be compatible.

# **Recommendation:**

Staff is recommending this application be approved if the railing is switched to match the rest of the site and the applicant agrees to not have signs on the umbrellas.

#### **Motion:**

THAT THE REQUEST BY THE JILL GROSNOFF ON BEHALF OF HUEY MAGOO'S FOR A CERTIFICATE OF APPROPRIATENESS TO ADD PATIO FURNITURE AND A RAILING AT 53 W. WILSON BRIDGE RD., AS PER CASE NO. ARB 72-2023, DRAWINGS NO. ARB 72-2023, DATED AUGUST 29, 2023, BE APPROVED BASED ON THE FINDINGS OF FACT AND CONCLUSIONS IN THE STAFF MEMO AND PRESENTED AT THE MEETING.

# D. Municipal Planning Commission – New Business

- 1. Amendment to Development Plan
- a. Signage 6670 Huntley Rd. (Chris Tilton) ADP 09-2023

# **Findings of Fact & Conclusions**

# **Background & Request:**

Tiltons Automotive Service is constructing its new 26,243 sf facility at this location and is now asking for approval of signage. The 2.57 acre property is located in the I-1 Zoning District (Restricted Light Industrial) at the northeast corner of Huntley Rd. and Schrock Rd.

# **Project Details:**

- 1. Three wall signs are proposed.
- 2. One sign each is shown on the south and west building elevations. These signs would be mounted on the building panels and consist of halo-lit channel letters and a car logo. Overall height is proposed as 4'1" and width is 10' for 40.8 sf per sign. Planned colors are red, white, and blue.
- 3. On the part of the building that faces the southwest corner of the property, a 10' x 28' panel is proposed with a 20'6" wide by 8' high red car that would be halo lit. The panel would be the sign area because without the sign, the panel would not be needed in that location. The actual sign would only be 164 sf.
- 4. Variances would be needed to have 3 wall signs and total sign area of 361.6 sf.

ARB-MPC Staff Memo Meeting September 14, 2023 Page 16 of 18

#### **Land Use Plans:**

# Worthington Code Sections:

# 1170.05 Commercial and Industrial District Requirements.

- (a) <u>Sign area</u>. Allowable permanent sign area for any single business shall be limited according to the widths of the building or part of the building occupied by such enterprise. For the purposes of this section, width shall be measured along the building face nearest parallel to the street line. In the case of a corner lot, either frontage may be used in determining maximum area for signage. The area of all permanent signs for any single business shall be equivalent to one and one-half square feet of sign area for each lineal foot of width of the building or part of the building, but shall not exceed a maximum area of 100 square feet per business.
- (b) Wall-mounted signage. Each business shall be permitted one wall-mounted sign.

# Worthington Planning & Zoning Code – Development Plan – 1175.02

Properties located in any "C-3" or "I-1" Districts that is not less than 2-acres in size shall be required to submit a Preliminary and Final Development Plan for the development of the site. The Preliminary and Final Development Plan looks at the location and character of the development, building heights, site layout, screening, landscaping, tract coverage, parking, utilities and stormwater control. Any changes to an approved Development Plan will be required to go through the Amendment to Development Plan process that would need to be reviewed and approved by the Municipal Planning Commission and possibly City Council if variances are needed.

# Comprehensive Plan Update & 2005 Strategic Plan for Worthington

The 2005 Comprehensive Plan Update recommends Restricted Light Industrial (I-1 District) for Huntley Road north of Schrock Road and General Industrial (I-2 District) for the area south of Schrock Road down to Dublin-Granville Road (SR-161).

Worthington's industrial corridor is significant to the City because these uses contribute to the tax base and provide employment opportunities for its residents. It is an appropriate site for industry, providing an edge for the brewery to the east in Columbus and straddling the railroad tracks. Truck traffic uses Schrock, Huntley, and Busch Boulevard to access SR-161 to Interstate 71.

Based on the competitive regional environment in the industrial market and the lack of large undeveloped parcels, the focus in Worthington should be on maintenance, marketing, and reuse of existing structures. The real estate economics make razing and redeveloping sites difficult without a larger, coordinated effort to assemble land. The Economic Development Plan indicated that Worthington is still able to attract small to medium-sized manufacturers and distributors but has difficulty retaining them as they grow and expand. These users should continue to be the target market, with structures renovated where possible to flexible space, easily converted for the changing needs of the tenant or new lessee.

The corridor consists of a number of buildings of various sizes and arrangements, as well as a few vacant lots. Because of the general age of the corridor and larger size of competing areas,

ARB-MPC Staff Memo Meeting September 14, 2023 Page 17 of 18 Worthington's industrial corridor is attractive to small and medium-sized manufacturers and distributors as well as business startups. The corridor still has the advantages of access to the rail line, proximity to the freeway system, close labor pool, and a location within the Outerbelt.

It is critical that the City protect this area as an employment center. The City should strive to make this area attractive to investment and redevelopment.

#### **Recommendation:**

Staff is recommending <u>approval</u> of this application as the proposed signs are acceptable at this location.

# **Motion:**

THAT THE REQUEST BY CHRIS TILTON TO AMEND THE DEVELOPMENT PLAN BY ADDING SIGNAGE AT 6670 HUNTLEY RD., AS PER CASE NO. ADP 09-2023, DRAWINGS NO. ADP 09-2023, DATED SEPTEMBER 5, 2023, BE RECOMMENDED TO THE CITY COUNCIL FOR APPROVAL BASED ON THE PLANNING GOALS OF THE CITY, AS REFERENCED IN THE <u>LAND USE PLANS</u>, AND ON THE FINDINGS OF FACT AND CONCLUSIONS IN THE STAFF MEMO AND PRESENTED AT THE MEETING.



# **ARB APPLICATION** ARB 0062-2023 171 E. Granville Rd.

Architectural Review Board 08/08/2023 Plan Type: Project: App Date:

Work Class: Certificate of Appropriateness Exp Date: City of Worthington District:

Completed: In Review Status:

**Approval** \$10,000.00 Valuation:

**Expire Date:** Description: Paint current siding Navy blue. Sherwin williams vinyl safe color "Grey Jacket" keeping a white trim.

Install new roof. Black in color.


100-000476 Main Address: 171 E Dublin-Granville Rd Main Parcel: Zone: R-10(Low Density Residence)

Worthington, OH 43085

Applicant / Owner Jake Rankey 796 MORNING ST Worthington, OH 43085 Mobile: (937) 409-8649

Invoice No.	Fee		Fee Amount	<b>Amount Paid</b>
INV-00004369	Architectural Review Board		\$10.00	\$10.00
		Total for Invoice INV-00004369	\$10.00	\$10.00
		Grand Total for Plan	\$10.00	\$10.00

# 171 E. Granville Rd.

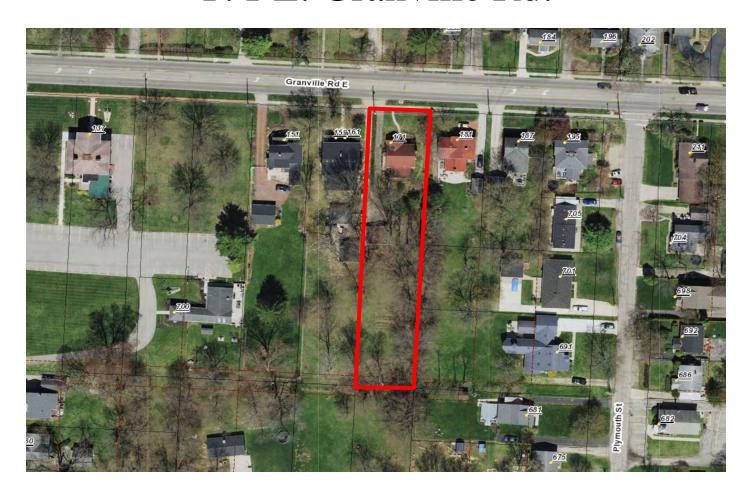











# **ARB APPLICATION** ARB 0063-2023 671 High St.

City of Worthington

Architectural Review Board Plan Type:

Project:

App Date:

08/09/2023

Status:

Work Class: Certificate of Appropriateness

District:

Worthington, OH 43085

Exp Date:

Completed:

In Review

Valuation: \$7,000.00 **Approval** 

Description: Additional HVAC System installed on rear flat roof. this is not visable from ground level

**Expire Date:** 

100-000037 Parcel:

Main Address: 671 High St Main

Zone: C-5(Central Commercial)

Applicant

Owner

Brian R Swanson

Sam Baker

230 FRANKLIN AVE

Mobile: (614) 561-1354


Worthington , OH 43085 Mobile: 6145887193


Invoice No.	Fee		Fee Amount	<b>Amount Paid</b>
INV-00004370	Architectural Review Board		\$7.00	\$7.00
		Total for Invoice INV-00004370	\$7.00	\$7.00
		Grand Total for Plan	\$7.00	\$7.00

# 671 High St





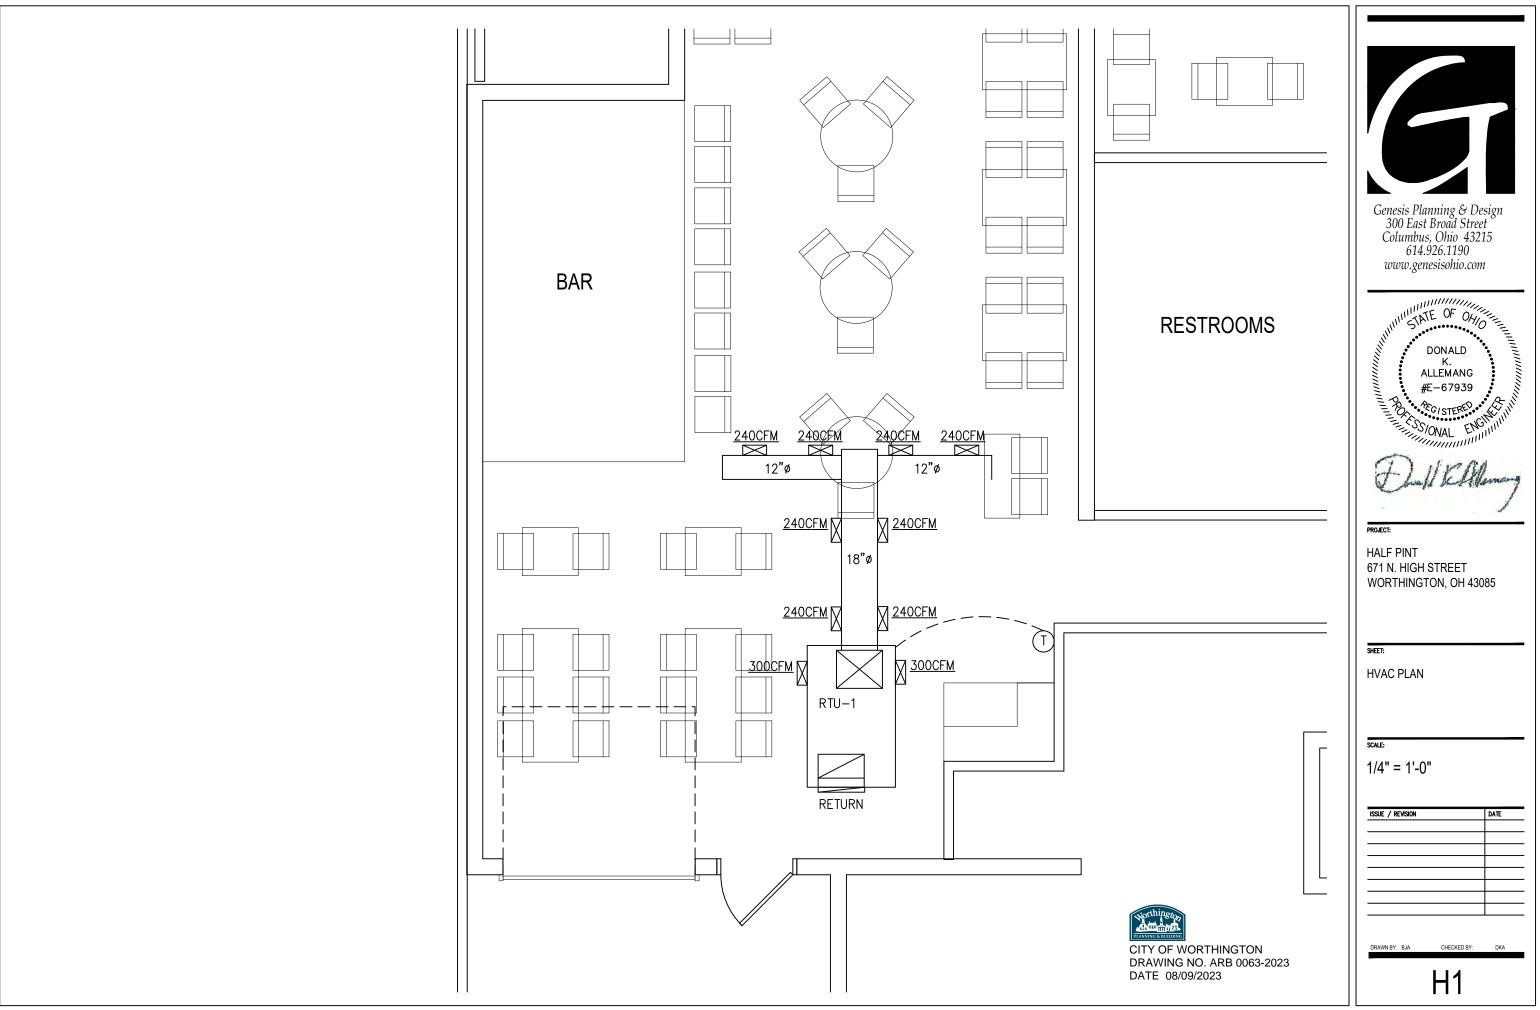


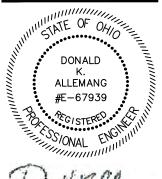

ISSUE / REVISION	DATE

TAG	DESCRIPTION	MODEL	VOLTS PHASE	MCA	MOCA	TONS	DESIGN CFM	DESIGN HEATING BTU'S	DESIGN COOLING BTU'S	UNIT WEIGHT	DIMENSION
RTU-3	ROOF TOP UNIT	BRYANT: 580JP07A115A1	208V, 3PH	30.5	45.0	6.0	2,400 CFM	115,000/93,000	71,800	652 LBS	33.385"HX91.1"WX131.6"L

FRESH AIR SCHEDULE								
DESCRIPTION	S.F.	S.F. O.A.	OCCUPANTS	OCCUPANT CFM	TOTAL O.A. REQ'D	Ez	SUPPLY AIR	FRESH AIR
DINING	514 S.F.	92 CFM	30	225 CFM	281 CFM	0.8	1800 CFM	450 CFM

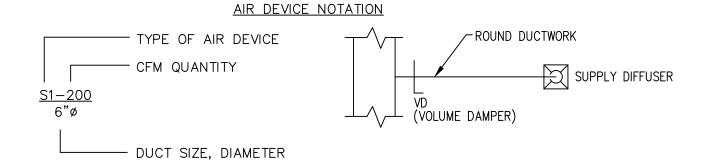

	HVAC SCHEDULE
(T)	THERMOSTAT 24/7 PROGRAMMABLE
S1	2'X'2' SUPPLY DIFFUSER TITUS OMNI SERIES.
R1	2'X'2' RETUTN GRILLE 350RL



#### **HVAC SPECIFICATIONS**

#### PART 1 GENERAL

#### 1.0 SCOPE

- A. THE HVAC CONTRACTOR SHALL FURNISH ALL LABOR, MATERIAL, TOOLS AND EQUIPMENT REQUIRED FOR A COMPLETE INSTALLATION AND TESTING OF THE HVAC SYSTEM AS INDICATED ON THE DRAWINGS AND SPECIFICATIONS.
- B. SCOPE TO INCLUDE INSTALLATION OF THE NEW ROOF TOP UNIT SERVING THE DINING ROOM ADDITION.
- C. THE HVAC CONTRACTOR SHALL SECURE AND PAY FOR ALL PERMITS AND INSPECTIONS REQUIRED FOR HIS WORK.

#### 1.1 CODES AND STANDARDS

- A. ALL WORK, MATERIAL AND EQUIPMENT SHALL COMPLY WITH ALL REQUIREMENTS OF THE 2017 OHIO BUILDING CODE, 2017 OHIO MECHANICAL CODE (OMC), ICC/ANSI A117.1—2009 ACCESSIBILITY CODE, O.S.H.A. AND ALL ENFORCED STATE AND LOCAL CODES.
- B. ALL MATERIALS SHALL BE U.L. LISTED AND BEAR THE U.L. LABEL.

# PART 2 DUCTWORK AND DEVICES

#### 2.0 AIR DEVICES

- A. SUPPLY AIR AND RETURN DEVICES SHALL BE NEW TO MATCH THE BUILDING STANDARD FOR 2'X2' LAY-IN TYPE.
- B. AIR DEVICES SHALL MATCH BUILDING STANDARD COLOR AND FINISH.

#### 2.1 DUCTWORK

- A. DUCTWORK SHALL BE INSULATED GALVANIZED SHEET METAL AND FLEX SIMILAR TO TYPE USED IN BUILDING.
- B. CONTRACTOR SHALL PROVIDE AIR TIGHT SEAL ON ALL DUCTWORK.
- C. PROVIDE VOLUME DAMPERS FOR EACH BRANCH RUN TO ALLOW FOR SYSTEM BALANCING. DAMPERS SHALL BE SINGLE CROSS—BLADE UP TO 12" BLADE WIDTH AND MULTI—BLADE IN LARGER SIZES. DAMPERS MOUNTED IN DUCTS SHALL BE CONTROLLED BY A LOCKING QUADRANT POSITIONER WITH HANDLE FOR DUCTS WITH EXTERIOR INSULATION. PROVIDE SUITABLE EXTENSIONS FOR POSITIONERS EQUAL TO VENT LOCK 637. MULTI—BLADE DAMPERS SHALL BE OPPOSED BLADE WITH ADEQUATE LOCKING MEANS FOR STABLE POSITIONING. FURNISH ACCESS PANELS WHERE REQUIRED FOR ACCESS TO DAMPERS
- D. MATERIALS SHALL MEET ASTM E-84 STANDARDS FOR SMOKE DEVELOPMENT OF 150 OR LESS AND FLAME SPREAD OF 25 OR LESS.
- E. ELBOWS SHALL HAVE AN INSIDE RADIUS EQUAL TO THE DUCT WIDTH, IN LIEU OF WHICH DOUBLE WALL TURNING VANES HAVING EQUIVALENT OR LESS PRESSURE DROP ARE ACCEPTABLE.
- F. ALL MATERIALS EXPOSED ABOVE CEILING IN RETURN PLENUM SHALL CONFORM TO OMC 602.2.1

#### PART 3 CONTROLS

A. THERMOSTAT SHALL BE LOCATED AS INDICATED ON THE PLANS. PROVIDE NEW CONTROL WIRING REQUIRED.



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#### PROJEC

WORTHINGTON TAVERN 671 N. HIGH STREET WORTHINGTON, OH 43085

SHI

HVAC SCHEDULES

SCALE:

NONE

ISSUE / REVISION	DATE
PERMIT DRAWING	7-7-23

DRAWN BY: BJA

CHECKED BY:

H2

#### **ELECTRICAL SPECIFICATIONS**

PART 1 GENERAL

CITY OF WORTHINGTON DRAWING NO. ARB 0063-2023 DATE 08/09/2023

#### 1.0 GENERAL

- A. THE ELECTRICAL CONTRACTOR SHALL FURNISH ALL LABOR, MATERIAL, TOOLS AND EQUIPMENT REQUIRED TO INSTALL THE NEW ROOF TOP UNIT, CONVENIENCE RECEPTACLE AND DUCT DETECTOR WITH INDICATING DEVICE.
- B. THE ELECTRICAL CONTRACTOR SHALL SECURE AND PAY FOR ALL PERMITS AND INSPECTIONS REQUIRED FOR HIS WORK.
- C. PROVIDE ARC FAULT WARNING SHORT CIRCUIT CURRENT ON ALL PANELS AND MAIN

# 1.1 CODES AND STANDARDS

A. ALL WORK, MATERIAL AND EQUIPMENT SHALL COMPLY WITH ALL REQUIREMENTS OF THE 2017 OHIO BUILDING CODE, THE 2017 NATIONAL ELECTRICAL CODE (NEC), THE NATIONAL FIRE PROTECTION ASSOCIATION (NFPA), THE LATEST ADDITIONS OF THE ICC/ANSI A117.1—2009 ACCESSIBILITY CODE, O.S.H.A. AND ALL OTHER ENFORCED STATE AND LOCAL CODES.

# PART 2 CONDUIT, WIRE, BOXES AND DEVICES


- 2.1 CONDUIT
- A. ALL CONDUIT SHALL BE AS LISTED.
- B. RIGID, INTERMEDIATE GRADE, EMT, ARE PERMITTED FOR WIRING.
- 2.2 WIR
- A. ALL SINGLE CONDUCTOR POWER WIRE SHALL BE 600 VOLT, THWN OR THHN COPPER OR EQUIVALENT ALUMINUM CONDUCTORS, METAL CLAD (MC CABLE) IS ALSO PERMITTED.
- B. MINIMUM WIRE SIZE SHALL BE #12 AWG, EXCEPT WHERE OTHERWISE NOTED.
- C. CONDUCTORS FOR POWER FEEDERS AND BRANCH CIRCUITS SHALL HAVE CONDUCTOR IDENTIFICATION AS CALLED OUT FOR IN THE N.E.C. AND SHALL BE CONSISTENT THROUGHOUT.
- 2.3 BOXES
- A. OUTLET AND DEVICE WIRING BOXES SHALL BE SHEET STEEL WITH STAMPED KNOCKOUTS, THREADED SCREW HOLES AND ACCESSORIES FOR EACH LOCATION INCLUDING MOUNTING BRACKETS, STRAPS, CABLE CLAMPS, EXTERIOR RINGS AND FIXTURE STUDS.
- 2.4 DEVICES
- A. ALL WIRING DEVICES SHALL BE HEAVY DUTY, SPECIFICATION GRADE AS MANUFACTURED BY BRYANT, HUBBELL, LEVITON OR APPROVED EQUAL. FINISH SHALL BE WHITE UNLESS NOTED OTHERWISE OR SELECTED BY THE OWNER OR ARCHITECT.
- D. RECEPTACLES SHALL BE DUPLEX, 2 POLE, 3-WIRE NEMA 5-20R, GROUNDING TYPE RATED 20 AMP, 125VOLT.

#### PART 3 GROUNDING

- 3.1 GENERAL
- A. PROVIDE ALL MATERIALS AND LABOR REQUIRED TO INSTALL AN APPROVED GROUNDING SYSTEM TO A GROUND SOURCE AS DESCRIBED IN N.E.C. 250.
- B. GROUND ALL CONDUITS, FIXTURES, RECEPTACLES, MOTORS, PANELS AND OTHER EXPOSED NON CURRENT CARRYING METAL PARTS OR ELECTRICAL EQUIPMENT IN ACCORDANCE WITH ALL PROVISIONS LISTED IN THE N.E.C.
- C. PROVIDE AN INSULATED GROUND WIRE IN ALL FEEDER AND BRANCH CIRCUIT CONDUITS.

# PART 4 SYSTEMS

- 4.1 FIRE ALARM
- A. PROVIDE DUCT DETECTOR IN RETURN OF RTU WITH ACCESSIBLE REMOTE INDICATING DEVICE. ACTIVATION OF DETECTOR SHALL SHUT UNIT DOWN PER OMC 606.

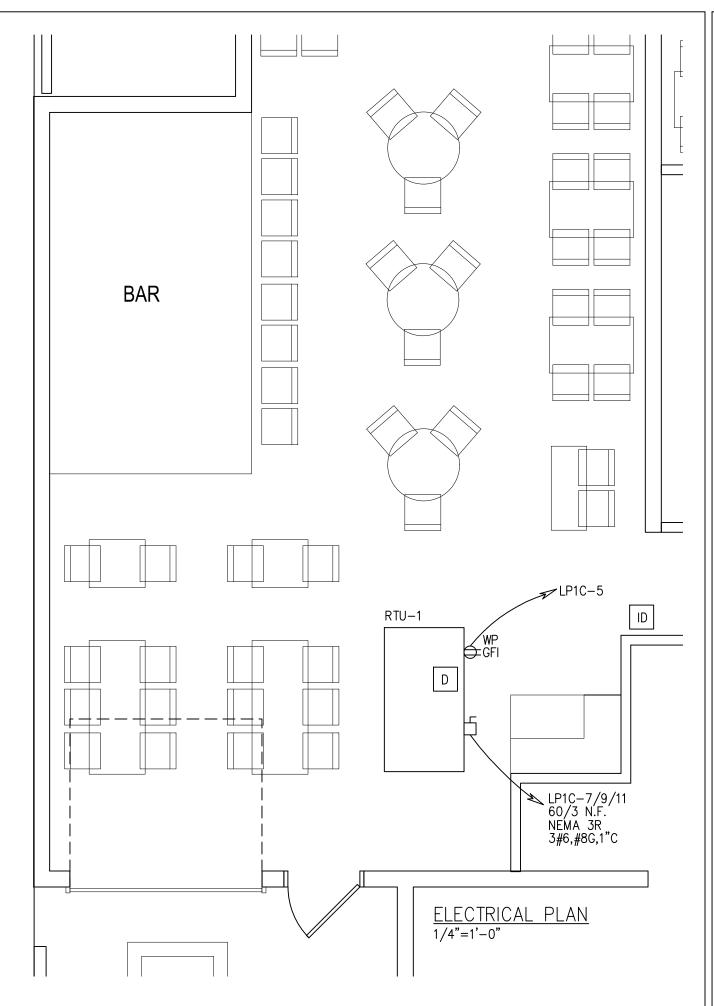



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PROJECT

WORTHINGTON TAVERN 671 N. HIGH STREET WORTHINGTON, OH 43085

SHEET

ELECTRICAL PLAN

SCALE:

1/4" = 1'-0"

SSUE / REVISION	DATE
ERMIT DRAWING	7-7-23

DRAWN BY: BJA CHECKED BY:


 $\mathsf{E}'$ 

	SYMBOLS			
Ф	STANDARD DUPLEX, 20A RECEPTACLE,			
	DISCONNECT SWITCH RATING AS INDICATED			
[ZZZ]	SURFACE MOUNTED PANEL BOARD			
ER	EXISTING TO REMAIN			
GFI	GROUND FAULT CIRCUIT INTERRUPTER			
WP	WEATHERPROOF, WEATHER RESISTANT ENCLOSURE			
NL	NITE LIGHT			
N.F.	NON FUSED			
ID	FIRE ALARM REMOTE INDICATING DEVICE			
D	FIRE ALARM DUCT DETECTOR IN RETURN			

EXISTIG PANELBOA AMPS: 150A MLO			VOLTAGE NQOD		3/120 DUNT			PH, 4 V URFACE	VIRE +	GND		
LOAD DESCRIPTION	LOAD KVA	C/B POLES	C/B AMPS	CIR. NO.	PI	HAS	E	CIR. NO.	C/B AMPS	C/B POLES	LOAD KVA	LOAD DESCRIPTION
SCREENS	1.0	1	20	1	Α			2	40	2	3.0	HEATER
LIGHTS/FANS	1.0	1	20	3		В		4	_	_	3.0	
RTU GFI	0.2	1	20	5			С	6	40	2	3.0	HEATER
RTU-1	3.0	3	45	7	Α			8	-	_	3.0	
	3.0	_	-	9		В		10	40	2	3.0	HEATER
	3.0	_	_	11			С	12	_	_	3.0	
SPARE		1	20	13	Α			14	40	2	3.0	HEATER
SPARE	.	1	20	15		В		16	_	_	3.0	
SPARE		1	20	17			С	18	40	2	3.0	HEATER
		1	20	19	Α			20	_	_	3.0	
		1	20	21		В		22	20	1	•	
		1	20	23			С	24	20	1		
		1	20	25	Α			26	20	1		
		1	20	27		В		28	20	1		
		1	20	29			С	30	20	1	•	•
		1	20	31	Α			32	20	1		
		1	20	33		В		34	20	1		
		1	20	35			С	36	20	1		
	.	1	20	37	Α			38	20	1		
		1	20	39		В		40	20	1		
		1	20	41			С	42	20	1		


FED FROM: SERVICE

DEMAND LOAD 41.0 KVA 113.8A @ 208V

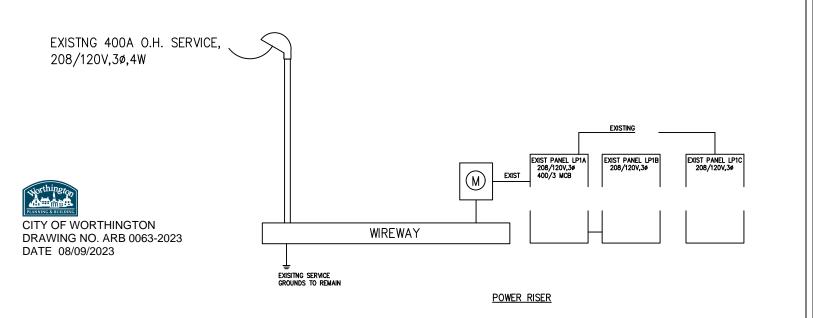



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PROJE

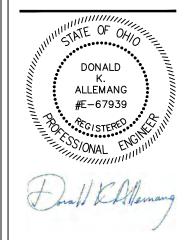WORTHINGTON TAVERN 671 N. HIGH STREET WORTHINGTON, OH 43085

SHEET

ELECTRICAL DETAILS

SCALE:

NONE

ISSUE / REVISION		DATE
PERMIT DRAWING	i	7-7-23
		+
		1
DRAWN RV: RIA	CHECKED BV:	DΚΔ

E2



# **ARB APPLICATION** ARB 0065-2023 6500 N. High St.

Architectural Review Board 08/16/2023 Plan Type: Project: App Date:

Exp Date: Work Class: Certificate of Appropriateness District: City of Worthington

Completed: Status: In Review

Approval \$72,023.00 Valuation: **Expire Date:** 

Description: Installing a MagneGrip source capture exhaust removal system

100-006588 Main Main Parcel: Address: 6500 N High St **Zone:** C-3(Institutions and Offices) Worthington, OH 43085

Owner Applicant Mark Zambito Kerry Stanforth 6500 N HIGH ST 11449 Deerfield Rd Worthington, OH 43085 Cincinnati, OH 45242

Mobile: (614) 436-3100 Business: (513) 489-4440


# 6500 N. High St.







# Example from other location

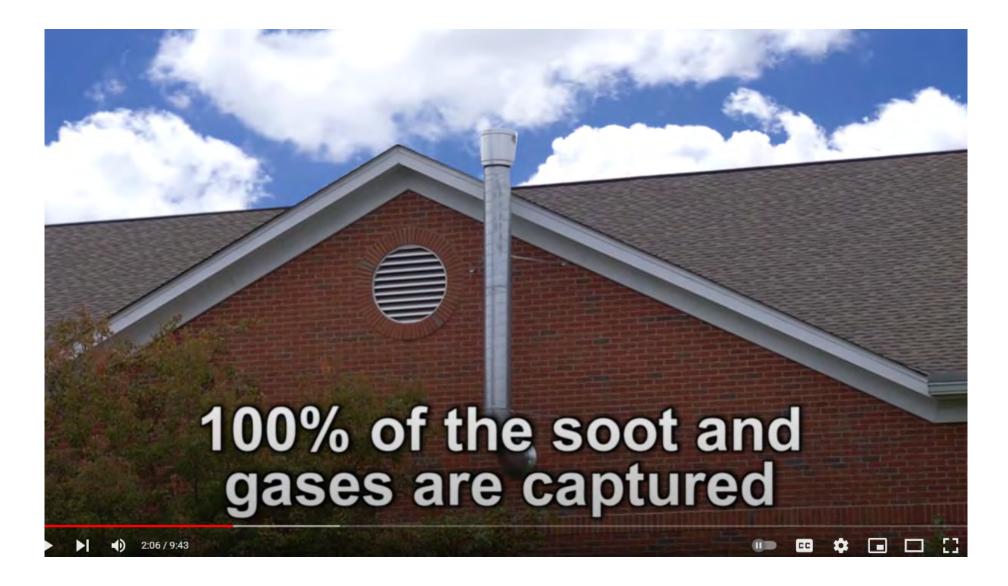

#### PROFESSIONAL SERVICES AGREEMENT

This Professional Services Agreement ("Agreement") is made on MM, DD, YY between the City of Worthington, Ohio (the "City") at 6500 North High Street, Worthington, Ohio 43085, and MagneGrip an Ohio corporation, with a mailing address of 11449 Deerfield Rd. Cincinnati, OH 45242 (the "Vendor"), for the installation, training, and purchase of a Long Rail Option Source Capture Exhaust System at the Division of Fire & EMS Department.

# **Statement of Agreement**

The parties acknowledge the accuracy of the foregoing Background Information and in consideration of the mutual promises contained in this Agreement, hereby agree as follows:

- 1. <u>Scope of Services</u>. The Vendor shall provide the Services to the City under this Agreement as outlined in the "Scope of Services attached hereto as Exhibit "A" and made a part hereof. Unless expressly provided in this Agreement to the contrary, the materials provided to the City by the Vendor and contained in its proposal dated February 24, 2023 (the "Proposal") shall be made a part of this Agreement and incorporated therein.
- 2. <u>Certification of Vendor Regarding Debarment</u>. By submitting a bid, the Vendor certifies that neither it nor its principals are presently debarred or suspended by any federal department or agency from participation in this transaction.
- 3. Relationship. For all purposes under this Agreement, the Vendor is an independent contractor and at no time shall serve in an employment relationship or represent service in an employment relationship with the City of Worthington. As such, the Vendor is solely responsible for the payment of all compensation, taxes, withholdings, and insurance for its employees, including workers' compensation coverage throughout the duration of this Agreement and any extension thereof. The City of Worthington is hereby released from any and all liability for injury received by the Vendor, its employees, agents, or sub-vendors, while performing tasks, duties, work, or responsibilities as set forth in this Agreement. The City of Worthington enters into this Agreement in reliance upon the Vendor's representation and warranty that it has the necessary expertise and experience to perform its obligations hereunder. Furthermore, if the Vendor is a business entity, Vendor warrants that it possesses the legal authority to enter into this Agreement and that it has taken all actions required by its procedures, bylaws, and/or applicable law to exercise that authority, and to lawfully authorize its undersigned signatory to execute this Agreement and to bind the Vendor to its terms. The person executing this Agreement on behalf of the Vendor warrants that such person had full authorization to execute this Agreement.
- 4. No Broker or Commission Fees or Conflicts. The Vendor warrants that it has not employed or retained any company or person other than a bona fide employee working solely for the Vendor to solicit or secure this Agreement, and that the Vendor has not paid or has not agreed to pay any fee, commission, percentage, brokerage fee, or other consideration contingent upon or resulting from the awarding or making of this Agreement. The Vendor warrants that it is not prohibited from contracting with the City by any provision of the Ohio Revised Code relating to conflicts of interest, illegal interest in government contracts, or any other ethical prohibition. For breach or violation of this warranty, the City shall have the right to annul the Agreement with no further obligation or penalty and shall have the right to recover the full amount of any such fee,

- commission, percentage, brokerage fee, or contingent fee and the full amount of the costs of the Agreement.
- 5. Proposal and Contract Information is Public. The Vendor acknowledges that all documents submitted with any proposal may become public documents and shall be subject to Ohio Revised Code Section 149.43, which is otherwise known as the "Ohio Public Records Law". By submitting any document to the City of Worthington in connection with a Proposal or Contract, the Vendor waives any claim against the City of Worthington and any of its officers and employees relating to the release of any document or information submitted. Furthermore, the Vendor agrees to hold the City of Worthington and its officers and employees harmless from any claims arising from the release of any document or information made available to the City of Worthington arising from or related to the Proposal or Agreement.
- 6. Payment for Services. Compensation for the stated Scope of Services shall be paid based on received products and services. The Vendor shall invoice the City in a manner acceptable to both parties. All invoices shall match the itemized price and structure submitted with the bid. Failure to have the invoice match the bid proposal may result in delay of payment and/or rejection of invoice. Additional charges not included or identified in the RFP will ne be accepted or paid. The Vendor shall reference the following information on all invoices:
  - a. Vendor Name
  - b. Date of Order
  - c. Invoice Number
  - d. Itemized list of items ordered
  - e. Itemized list of items shipped
  - f. Quantity, unit price and extension price of each item and total price of order
- 7. Obligations of the City. The City shall provide all criteria and full information as to is requirements of the project to the Vendor and shall designate a representative from the City to act with authority on the City's behalf with respect to the Consultant's provision of the Services. The City's designated representative shall examine and timely respond to the Vendor submissions and shall provide written notice to the Vendor whenever the City observes or otherwise becomes aware of any detail that deviates from the terms of this Agreement.
- 8. Non-Discrimination. During the performance of the Agreement, the Vendor agrees that the Vendor, its sub-contractors, employees, and agents, will not discriminate against any employee or applicant for employment because of race, sex, sexual orientation, gender identity or expression, color, religion, ancestry, national origin, age, disability, familial status, or military status, which employee or applicant for employment is qualified and available to perform the work to which the employment relates.
- 9. <u>Insurance</u>. The Vendor shall comply with the laws of the State of Ohio relating to insurance coverage and shall carry during the performance of the Contract and keep in full force, Workers' Compensation, in amounts required by law, covering all the Vendor's employees. Upon request, the Vendor shall furnish documents evidencing such Workers' Compensation to the City prior to the commencement of the Services and at any time during the Agreement. The Vendor shall carry the following minimum amounts of General and Automobile Liability Insurance, with the City named as the additional insured, each with the following limits:

- a. General Liability Insurance in the amount of \$500,000 for bodily injuries including those resulting in death of any one person and on account of any one accident or occurrence, \$1,000,000 aggregate.
- b. Automobile Liability Insurance in an amount of \$500,000 from damages on account of any one accident or occurrence.

The Vendor shall provide the City with Certificates of Insurance indicating coverage and conditions stipulated herein prior to the commencement of the Services, with the City named as an additional insured thereon.

- 10. <u>License</u>. The Vendor shall procure at its own expense and maintain in full force and effect during the life of the Agreement, all licenses required by the city, state, and federal governments relative to the performance of the terms and conditions set forth therein.
- 11. <u>Applicable Laws</u>. The Vendor agrees to comply with all applicable federal, state, and local laws, including the Charter and Codified Ordinances of the City of Worthington. Legal action to enforce this Agreement shall only be brought in a court of competent jurisdiction in Franklin County, Ohio.
- 12. <u>Income Tax</u>. The Vendor shall withhold all applicable City of Worthington income taxes due or payable under the provisions of Part Seventeen Title Two (Taxation Code) of the Codified Ordinances of the City for wages, salaries and commission paid to its employees and further shall be required to withhold any such City of Worthington income taxes for payments made to subcontractors.
- 13. <u>Prevailing Wages</u>. If applicable to this Agreement, the Vendor agrees to comply with the Davis-Bacon Act, as amended, 40 U.S.C. 3141 et seq., the Copeland "Anti-Kickback" Act, as amended, 18 U.S.C. 874, and the Contract Work Hours and Safety Standards Act, as amended, 40 U.S.C. 3701 et seq., regarding labor standards for federally assisted projects, as well as the prevailing wage laws of the State of Ohio.
- 14. <u>Indemnification</u>. The Vendor shall indemnify, defend, and hold harmless the City, its elected officials, officers, employees, agents or any of them, from and against claims, damages, losses and expenses, including but not limited to reasonable attorneys' fees, arising out of the negligent acts or omissions of the Vendor, to the extent caused in whole or in part by the negligent acts or omissions of the Vendor, any subcontractor(s) of the Vendor, its agents, or anyone directly or indirectly employed by them or anyone for whose acts they may be liable. Such obligations shall not be construed to negate, abridge, or reduce other rights or obligations of indemnity that would otherwise exist as to a party or person described in this paragraph. The City shall not indemnify or hold harmless the Vendor, its officers, employees, agents and subconsultants for claims, damages, losses and expenses, including but not limited to reasonable attorney fees, resulting or arising from the Agreement.
- 15. Federal Provision 2 CFR §200.326. For construction or facility improvement contracts or subcontracts exceeding the Simplified Acquisition Threshold, the Federal awarding agency or pass-through entity may accept the bonding policy and requirements of the non-Federal entity provided that the Federal awarding agency or pass-through entity has made a determination that the Federal interest is adequately protected. If such a determination has not been made, the minimum requirements must be as follows:
  - a. A bid guarantee from each bidder equivalent to five percent of the bid price. The "bid guarantee" must consist of a firm commitment such as a bid bond, certified check, or other negotiable instrument accompanying a bid as assurance that the bidder will, upon

- acceptance of the bid, execute such contractual documents as may be required within the time specified.
- A performance bond on the part of the contractor for 100 percent of the contract price.
   A "performance bond" is one executed in connection with a contract to secure fulfillment of all the contractor's requirements under such contract.
- c. A payment bond on the part of the contractor for 100 percent of the contract price. A "payment bond" is one executed in connection with a contract to assure payment as required by law of all persons supplying labor and material in the execution of the work provided for in the contract.
- 16. <u>Civil Rights Act of 1964</u>. Vendors must comply with the requirements of Title VI of the Civil Rights Act of 1964 (codified as amended at 42 U.S.C. § 2000d et seq.), which provides that no person in the United States will, on the grounds of race, color, or national origin, be excluded from participation in, be denied the benefits of, or be subjected to discrimination under any program or activity receiving federal financial assistance. DHS implementing regulations for the Act are found at 6 C.F.R. Part 21 and 44 C.F.R. Part 7.
- 17. <u>Lobbying</u>. Vendors must comply with 31 U.S.C. § 1352, which provides that none of the funds provided under a federal financial assistance award may be expended by the recipient to pay any person to influence, or attempt to influence an officer or employee of any agency, a Member of Congress, an officer or employee of Congress, or an employee of a Member of Congress in connection with any federal action related to a federal award or contract, including any extension, continuation, renewal, amendment, or modification.
- 18. <u>FEMA Grant Requirements</u>. This Agreement hereby incorporates any additional terms and conditions under the federal requirements contained in 2 C.F.R. §200.317-326 necessary for FEMA to fully reimburse eligible expenses to the City.
- 19. <u>Term of Agreement</u>. This Agreement shall be for the term set forth by the period of performance of products & services of the FY2021 Assistance to Firefighters Grant (AFG) award. All implementation, training, and services as described in Exhibit "A" shall be provided in full by September 9, 2024.

The parties, each by a duly authorized representative, have executed this Agreement to be effect as of the date last written below:

CITY OF WORTHINGTON	MAGENEGRIP

Robyn M. Stewart Robyn M. Stewart (May 19, 2023 08:48 EDT)	05/19/2023	Milosoman	04/25/23
Robyn Stewart Acting City Manager	Date	Authorized Representative	Date
Approved as to form:		Approved & Reviewed:	
Tom Lindsey	05/18/2023	John Moorehead John Moorehead (May 18, 2023 15:56 EDT)	
Tom Lindsey, Director of Law	Date	John Moorehead, Service & City of Worthington	Engineering Director

# PROPOSAL FOR THE PURCHASE OF A SOURCE CAPTURE EXHAUST SYSTEM

Rossman Enterprises dba as MagneGrip is pleased to offer its Bid for an automatic MagneGrip® Diesel Exhaust Removal System. The MagneGrip® System meets or exceeds <u>all</u> the performance and quality specifications contained within the bid documents. The MagneGrip® Product fully complies with the intent of the bid package to provide a fully functioning Vehicle Exhaust Removal System that will remove 100% of diesel exhaust emissions to the outside without leaking harmful diesel exhaust indoors.

**Exceptions: None, Fully Comply** 

### **Section 2: SCOPE OF PRODUCTS AND SERVICES**

### **System Description and Extraction System Overview:**

 ${
m MagneGrip}^{
m @}$  provides a complete 100% evacuation Source Capture Exhaust System. MagneGrip is the only company that offers a nozzle and adapter combination that is 100% closed and sealed and does not allow gases to escape.

MagneGrip has included 4 rails and 4 hose drops that provides the capability of coverage from the back door all the way to the front door. Fan is of sufficient size (4400CFM) to allow for 4 additional trucks to be added to the rail system.

### **Installation and Demolition**

An onsite survey has been completed and system layout drawing is included. All State and Federal Codes will be adhered to. Electrical permits have been included. MagneGrip will provide a turnkey installation including all aspects of the project including tailpipe modification and electrical work. Take down of existing system has been included, however, it is our understanding that the fire department wants to use the material for training and will be responsible for removal.

### **Training**

MagneGrip includes startup and training with its installation scope of work. Although the system is incredibly easy to use, we will be happy to meet and discuss any questions that the department may have.

### **Warranty**

A warranty certificate has been included within this book. A Five-Year Warranty is included with your order. The warranty will be honored directly from MagneGrip, Cincinnati, Ohio, the manufacturer and installer of your system. There will not be second party distributors or installers for warranty issues.

### **Maintenance and Service**

No regular maintenance is required to keep the warranty intact. Preventative Maintenance Agreement is offered as an optional service but is not required for warranty purposes. Service is offered from multiple locations within Ohio with base operations, Cincinnati. Information has been included with our bid book describing our service and helpdesk service operations. We take pride in providing the best service within the industry.

### **Period of Performance**

Typically, installation is completed within 90 -120 days after receipt of your order. We have multiple installation crews available to work on your project. We currently are not experiencing any major supply chain issues.

### **Letter of Intent**

Our proposal within the book provides the required signature and information requested in this section. The proposal and CAD drawing illustrate our understanding of the needs of the Fire Department for a fully functioning source capture Vehicle Exhaust Removal System as required by the AFG Guidelines and as discussed at a Prebid meeting.

### **Company Background**

A company background has been included in this book. MagneGrip has been installing Vehicle Exhaust Removal Systems in Fire Stations for over 25 years. MagneGrip specializes in this area, and it is our only business. No one has installed more systems in the State of Ohio as evident in our referral list.

MagneGrip is the originator of the Magnetic Release Nozzle and Adapter. Others are now imitating MagneGrip but, have their limitations.

MagneGrip is the most highly regarded Vehicle Exhaust Removal System in the State of Ohio. MagneGrip is installed in well over 300 fire departments within The State of Ohio approaching 1000 stations. No other company comes close to this level of experience.

### **References**

Four pages of references within the State of Ohio have been included. There are 8 departments that are in process that were ordered within the past few weeks. We are confident that they will provide good recommendations for our company and product.

We would recommend touching base with Jackson Township, BC Jim Parmenter; Madison Township, Chief Robinson; Delaware FD, Chief Donahue; West Licking, Chief Jack Treinsh; Truro Township, Chief Sharps. See installation pictures enclosed.

### Scope of Products and Services

These items all are covered here or within the book.

### **Costs**

MagneGrip provides the most **heavy-duty** equipment available. No short cuts have been taken. Costs include:

- Heavy duty industrial welded fan
- Larger spiral duct diameters for higher system performance
- Large suction rail system with external trolley wheels not mini rails or internal wheels
- Large 5-inch flex hose that matches or exceeds the vehicle's exhaust system diameter for better airflow
- Higher temperature flex hoses for safety
- Completely 100% sealed nozzle and adapter assemblies that are totally enclosed and made of rust proof components. No leaks and less maintenance.
- Cast aluminum components and internal stress management cables to lessen maintenance.
- Easiest system on the market for firefighters to use. See new MagneGrip PRO literature.

### **Terms and Conditions**

No exceptions requested. MagneGrip is the most advantageous system for Worthington FD for meeting the needs for a fully functioning Vehicle Exhaust Removal System, local service, and installation services and is Made in the USA, as preferred in AFG Guidelines.

### **Quality Assurance:**

Rossman Enterprises, Inc. dba MagneGrip, the manufacturer of the MagneGrip® System, and has an ISO9001:2015 certificate for manufacturing of equipment. We are the only American Company in the industry that can provide this. A current ISO Certificate has been included in *Forms & Certifications* Section.

MagneGrip has been manufacturing Vehicle Exhaust Removal Systems for Fire Stations for over 25 years with over 300 departments within the State of Ohio and thousands across the nation.

### **<u>Air Volume and Fan Requirements:</u>**

MagneGrip only uses 5-inch flex hose and larger to allow for maximum airflow. This will match or exceeds exhaust system diameters found on today's apparatus.

MagneGrip is providing a quality fan of welded construction. Some competitors do not offer this level of quality by offering screw together or pop riveted fan construction.

### **Turnkey Installation:**

All facets of the project have been included in our turnkey proposal.

The installation and equipment shall be provided directly from the manufacturer: Rossman Enterprises, Inc, dba MagneGrip, 11449 Deerfield Road, Cincinnati, Ohio 45242

Installation Project Mgr.: Paul Miller-over 30 years-experience with MagneGrip

Key Contact Person: Mike Winkler, Regional Manager-over 30 years' experience with MagneGrip

### **Nozzle Attachment:**

The MagneGrip® Nozzle and Adapter are a 100% sealed combination and does not allow for escaping gases. This is accomplished using a silicone gasket that serves as a check valve to prevent gases from escaping back into the bay. This occurs even if the fan does not activate. No other vendor can claim this level of quality.

### Nozzie Release:

MagneGrip has included an Internal Stress Cable to eliminate tugging and stress on the hose during hose transport and separation from the vehicle exhaust system. This helps reduce wear and tear, ripping of hoses, and maintenance costs. MagneGrip is the only company to incorporate this feature.

### **Suction Rail:**

The MagneGrip® Rail features external guide rails that allow the wheels to be outside of the airstream. This reduces the maintenance costs of cleaning wheels that are exposed to soot and heat. Other companies do not offer this level of quality. Large, 8-inch diameter duct material and transitions are used to extract contaminated air from the rail.

### **Extraction System Exhaust Hose:**

MagneGrip exceeds this specification by including a 950/1050F degree hose in its lower section. This hose is specially engineered to retain its shape and withstand the temperatures found in some of today's apparatus exhaust systems. No other company offers this level of quality.

### **Auto Start Control System:**

MagneGrip is using a NEMA4X Control Panel which provides watertight seal for safety.

### **System Warranty:**

MagneGrip exceeds the warranty specification by including a five-year parts and labor warranty with its Bid. See *Service & Maintenance* Section for Warranty Certificate. No special maintenance needs to be done to keep warranty in tack.

### **Point of Origin:**

MagneGrip® Systems are manufactured in Cincinnati, Ohio using 100% American parts provided from US vendors. AFG Guidelines require preference be given to American Manufacturing. We meet the requirement of the Buy American Act.

### **Additional Comments Regarding Bid Specifications**

**<u>BIDDER QUALIFICATIONS:</u>** MagneGrip is the <u>only</u> bidder that has been manufacturing magnetic hose connection nozzles for more than 25 years. References have been included for the State of Ohio.

**LOCATION POINT OF MANUFACTURER, INVENTORY, AND SERVICE:** MagneGrip® is manufactured in Cincinnati, Ohio and is the only major manufacturer in the industry that has its base headquarters in the USA. All equipment in this Bid is shipped directly from the manufacturer's warehouse. All vendors supporting the MagneGrip® System are based in United States. All equipment, inventory parts, and service are available to you directly from the factory based in Cincinnati, Ohio. An ISO9001-2015 certificate for manufacturing of product is included in the bid document, as required. **Please note**: no other company can provide an ISO Certificate for the manufacturing of goods in the USA.



### **Long Rail Option**

DATE: February 24, 2023

PROPOSAL FOR: Worthington Fire Department

> 6500 North High Street Worthington, OH 43085

ATTENTION: Mr. Scott Treadway-Facilities

REF: Source Capture Exhaust System

**PROJECT SCOPE:** Provide and Install a fully automatic MagneGrip® Diesel Exhaust Extraction System

for removal of apparatus exhaust emissions from start up to door threshold.

Removal of existing system is included.

### **EQUIPMENT, MATERIAL AND LABOR PRICE:**

#### Station #1:

Four Drop MagneGrip® Long Rail Source Capture System

Note: Bay numbers shown below are as depicted on enclosed drawing.

Package Includes:

(1) SSRMPRO-661 + Bay #1 : 66' Straight Suction Rail MagneGrip® PRO with one Hose Drop (1) SSRMPRO-661 - Bay #2 - 66' Straight Suction Rail MagneGrip® PRO with one Hose Drop Bay #3 - 66' Straight Suction Rail MagneGrip® PRO with one Hose Drop (1) SSRMPRO-661 Bay #4 - 66' Straight Suction Rail MagneGrip® PRO with one Hose Drop (1) SSRMPRO-661 (1) CF363-7.5 MagneGrip® Exhaust Fan 7.5HP-3PH rated at 4400 CFM at 6" SP

(1) 500181-08 Wireless Auto-Start Control Panel 7.5HP/208-230V/3PH

(1) 500157-14 14" Up-blast Back Draft Damper Type Rain Cap (1) 400073-02 MagneGrip® PRO Tailpipe Adapter 5" with Clamp

- Each Hose Assembly includes a 5" diameter high-temp upper hose section, a 950/1050-degree extreme high-temp 2' lower hose section with handle, a nozzle that attaches to the tailpipe adapter to contain 100% of exhaust emissions while providing ambient air to reduce exhaust temperatures, a tailpipe adapter assembly that provides easy connection and cool air induction.
- UL/CUL Wireless Auto-Start Control Panel with NEMA 4X enclosure to provide auto start/stop operation with adjustable timer, manual override switch, and wireless capability.
- Electrical wiring from available supply to control panel and exhaust fan, a safety disconnect for fan motor. Subpanels are excluded, if required, and any modifications required to bring service to code are excluded.
- Each Hose Assembly is provided with a transmitter and pressure sensor for automatic system.
- Tailpipe Modifications as required but, limited to vehicle tailpipes from the muffler out. Rusted or Damaged Tailpipes are the responsibility of the Fire Department.
- Class 2 Spiral Duct, Fittings, and Hangers











- Labor & Material to Install Systems
- Wall Penetration for Fan Discharge
- Start up and Training
- Equipment is 100% American Made by an ISO9001-2015 Company
- Women's Business Enterprise (WBE) Certified
- Women's Owned Small Business (WOSB) Certified

PRICE	. \$72,023.00
Option:	
(3) Annual Preventative Maintenance One Station @ \$500 per year  Please state	\$1,500.00 Yor N for option.

#### **TERMS:**

- One MagneGrip® Tailpipe Adapter and installation is included with each hose drop assembly. All vehicles that
  require Tailpipe Adapters must be made available to MagneGrip technicians at the time of system installation.
  Additional adapters upon request. Call for pricing.
- Unless otherwise noted in this proposal, pricing includes wall penetration for exhaust duct.
- Pricing includes standard permits and business licensing fees, if required. Price does not include any state, sales, or special taxes, engineered stamped drawings or services, seismic engineering, or electrical/structural load calculations.
- Electrical subpanels and modifications required to bring service to code are excluded if required unless otherwise indicated in the proposal.
- Upon approval, please submit a signed copy of this proposal and a tax exemption certificate. Projects are invoiced per station upon shipment of equipment. Payment is due upon completion of the project.

### **SUBMITTED BY:**

## MagneGrtp<sup>\*</sup>

Maggie Rossman-Roach

President

Signature: White Samuel

Date: 02/24/23

(Worthington, OH FD Bid Proposal dated 2-24-23) **ACCEPTED BY:** 

**Company: City of Worthington** 

Authorized Signature: Robyn M. Stewart (May 19, 2023 08:48 EDT)

Print: Robyn M. Stewart Title: Acting City Manager

PO#, If Required: 2023000036 Date: 05/19/2023







CITY OF WORTHINGTON DRAWING NO. ARB 0065-2023

DATE 08/16/2023

# MagneGrip - Source Capture Exhaust System (CIP 741-23)

Final Audit Report 2023-05-19

Created: 2023-05-17

By: Sarah Brickner (sarah.brickner@worthington.org)

Status: Signed

Transaction ID: CBJCHBCAABAAX8R52MA81bJ8wz2-gCjukTsN\_mO4nNfJ

## "MagneGrip - Source Capture Exhaust System (CIP 741-23)" Hi story

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- Email viewed by Tom Lindsey (tom.lindsey@worthington.org)
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- Document e-signed by Tom Lindsey (tom.lindsey@worthington.org)

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- Signer john.moorehead@worthington.org entered name at signing as John Moorehead 2023-05-18 7:56:20 PM GMT- IP address: 198.30.235.200
- Document e-signed by John Moorehead (john.moorehead@worthington.org)

  Signature Date: 2023-05-18 7:56:22 PM GMT Time Source: server- IP address: 198.30.235.200
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Document e-signed by Robyn M. Stewart (robyn.stewart@worthington.org)

Signature Date: 2023-05-19 - 12:48:49 PM GMT - Time Source: server- IP address: 198.30.235.200


Agreement completed. 2023-05-19 - 12:48:49 PM GMT





Submittal Pages For

## STRAIGHT SUCTION

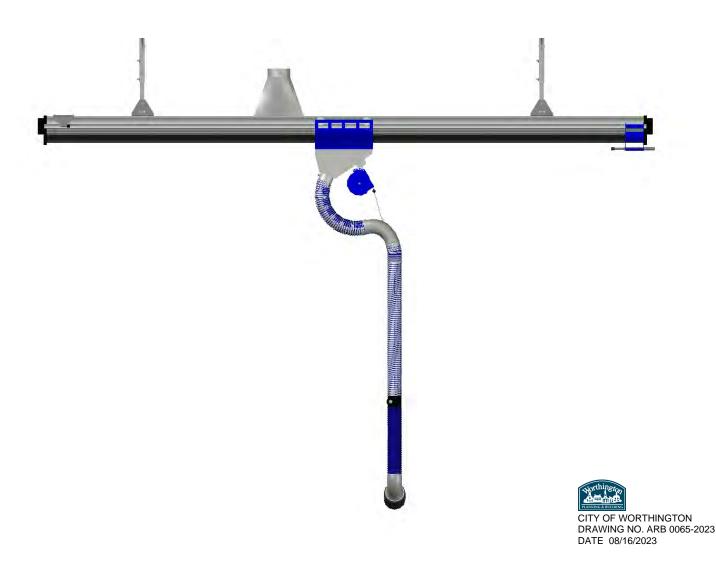

Manufactured by:

MagneGrip\*

11449 Deerfield Road Cincinnati, OH 45242 info@MagneGrip.com Phone: 800-875-5440 Fax: 513-247-2502



### Straight Suction Rail (SSR)



Suction rails are especially advantageous in stations where vehicles drive through a building or when vehicles are parked in tandem one behind another. The suction rail transports air for removal from the building, the rail can accommodate up to four emergency vehicles parked in tandem. because the system uses a rail transport air the amount of flex hose is minimized providing a neat, clean installation in drive through bays. the SSR can be used with MagneGrip system or pneumatic HazVent system.

A trolley with external wheels which roll on the outside of the rail mount and travel back and forth with the vehicle the hose connects to an inlet plenum at the base of the trolley and rubber lips sealed the rail to prevent escaping of gases when the vehicle exits the station at the nozzle automatically disconnects at the threshold.






Architect:	Project Name:
Contractor:	Date:




## Straight Suction Rail Profile

### SSRM 602 TYPICAL DRAWING LAYOUT

SUBMITTLE DRAWING TYPICAL LAYOUT (DRIVE THROUGH) SSR-602 TWO VEHICLES

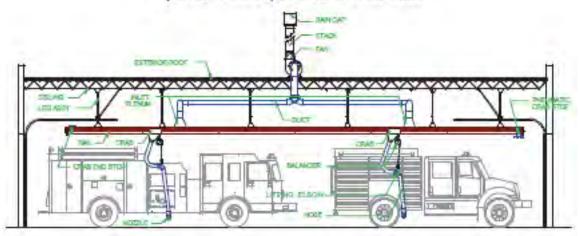

#### SUBMITTLE DRAWING TYPICAL LAYOUT SSR-602 TEVHICLE - PLAN VIEW

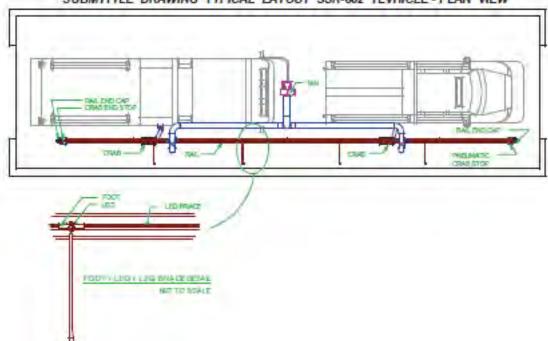






Architect:	Project Name:
Contractor:	Date:



## **SSRMPRO System breakdown**

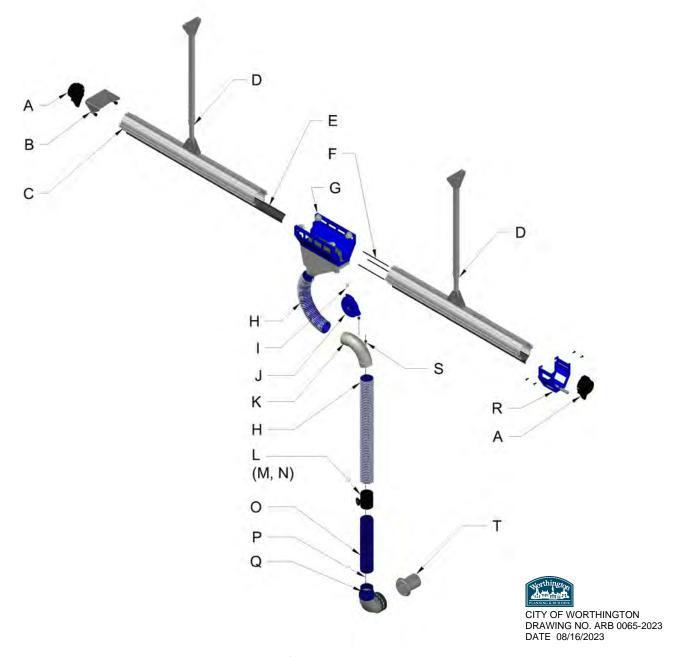

A: 520024-01 SSR endcap 6"

B: 520030-01 Rear SSR end stop

C: 520023-06 6"x6' Straight suction rail

D: 500047-02 Leg assy. w/ feet

E: 520032-03 Lip insert for rail

F: 520040-02 rail connector pin

G: 520020-04 Crab Assy.

H: 500095-11 Blue/White Hose 5"x11'

I: 500065-01 Swivel "H" for balancer

J: 500084-04 Blue balancer Assy.

K: 530408-05 Lifting Elbow Assy. 5"

L: 530622-02 Handle/Knob 5" Assy.

M: 500071-05 Pressure Sensor

N: 540557-02 Transmitter standard

O: 430630-02 5X2' MGPRO Lower hose

P: 500002-75 MGPRO INNER HOSE CABLE

Q: 400076-02 MGPRO Nozzle Assy

R: 520049-08 SSR Shock absorber endstop

S: 500002-76 MGPRO INNER CABLE SPRING


5000084-08 BALANCER BALL STOP

T: 400073-02 MGPRO TAILPIPE ADAPTOR 5"

U: 500084-25 Balancer Safety Cable (not shown)



## Straight Suction Rail Technical Information

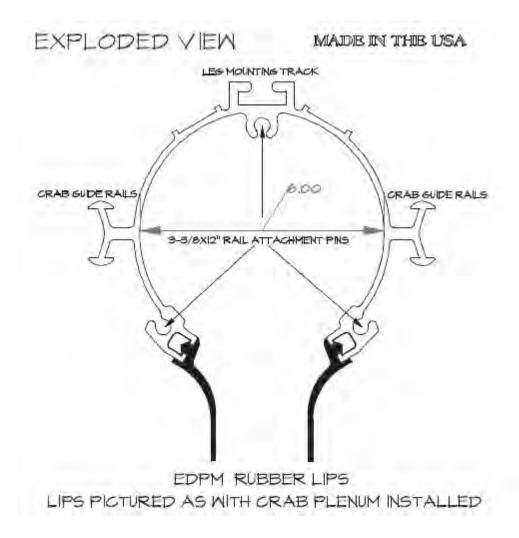

- ★ Made from 6063-T5 Aluminum with a mill finish and delivered in 6-foot lengths
- ★ Weight per foot 6.3lbs for 37.8 lbs. per 6' section
- ★ Wall thickness .150, rail is manufactured as an extrusion and is designed to serve as a ventilation tube
- ★ Guide rails are designed to support crab assembly as it slides along its length
- ➤ Suction rail incorporates a set of EDPM lips that tightly seals the rail to the crab assembly roller cone while the system is in use allowing for effective removal of all exhaust fumes from the tailpipe as the crab moves along the rail until automatic release





Architect:	Project Name:
Contractor:	Date:



## Straight Suction Rail EDPM Lips



- ★ Made from EDPM rubber with a durometer of 70
- ➤ Designed to be installed into the Straight Suction Rails to seal them while allowing the crab assembly to move and well suited to handle exhaust temperatures
- ★ Excellent resistance to UV and weathering
- ★ Designed with friction reduction groves to lower the crabs rolling resistance during operation
- ★ Manufactured in standard lengths of 62'


WORTHING OF THE PROPERTY OF TH
CITY OF WORTHINGTON
DRAWING NO. ARB 0065-2023
DATE 08/16/2023



Architect:	Project Name:
Contractor:	Date:



## Straight Suction Rail Adjustable Shock Absorber End-stop Assembly

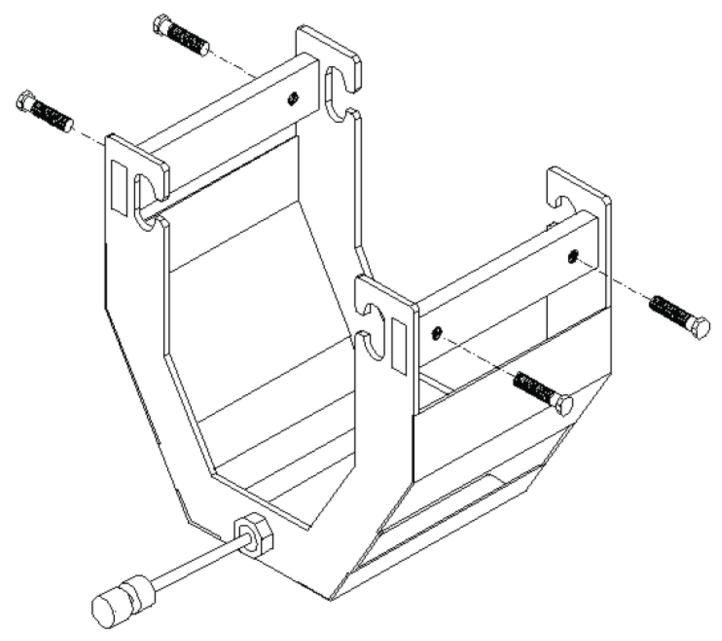





Architect:	Project Name:
Contractor:	Date:



## Straight Suction Rail Adjustable Rear End-stop Assembly



- ★ Designed to fit both the 6-inch and 9-inch Suction Rails
- ★ Mounts directly to the center top slot using standard clamp plate and hardware
- ★ Made from powder coated cold rolled steel
- ★ Incorporates conical cone rubber bumpers to cushion the stop of the crab assembly







Architect:	Project Name:
Contractor:	Date:



## Aluminum Telescopic Leg and Foot Assembly

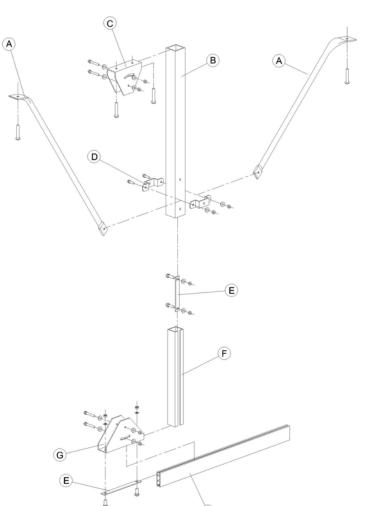



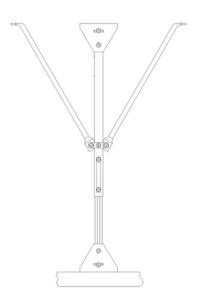

- ➤ Outer tube 1 7/8" x 72", inner tube "c" channel construction 1 1/2" x 72" x 1/2" opening, wall thickness at 3/4" both inner and outer tubes designed to slide together and adjustable by using clamp plate.
- ★ Material 6063-T6 aluminum, with a mill finish.
- ★ Upper- and lower-foot assemblies made from 11-gauge g-60 galvanized steel, supplied with mating clamp plate and hardware. supplied with leg brace clamp assemblies for added support





Architect:	Project Name:
Contractor:	Date:



## MagneGrip Lifting Elbow

Available in 4- and 5-inch diameters





- ★ 90 Degree Lifting elbow ensures that the hose is lifted and kept out of the way while allowing for unrestricted airflow while eliminating the hose collapse associated with using a molded rubber saddle
- ★ Lifting eye with 37.5 deg offset allows for proper alignment of hose to nozzle assembly
- ★ Made from 16 ga cold rolled steel and powder coated for long life and durabilty



Architect:	Project Name:
Contractor:	Date:



## Stainless Steel Double "H" Swivel



- ★ Forged 316 Stainless Steel
- ★ 2-5/8 inches long by ¼ inch diameter, threaded ends with lock nuts
- ★ Rated for 600lbs
- ★ Attaches balancer to trolley or plenum
- \* Allows balancer to align and adjust to vehicle location during movement in the bay





Architect:	Project Name:
Contractor:	Date:



## **B**alancer



- ★ Hose Balancer is non-locking with adjustable lifting capacity of 20-27 lbs.
- ★ Balancer cable shall incorporate a .080 diameter coated steel cable
- Safety cable assembly included
- ★ Housing shall incorporate a high impact designed and finished in powder coated blue color





Architect:	Project Name:
Contractor:	Date:



## MagneGrip 400°+ Double ply Acrylic Coated Exhaust Hose



- ➤ Hose shall be high-temperature, double-ply, acrylic-coated, blue polyester fabric construction with a continuous operating range of up to 400 degrees (F) with an intermittent temperature of 550 degrees (F)
- ★ Listed as UL 94V-0 flame retardant
- ★ Hose shall incorporate a ¾" bound spring steel wire helix, a wear strip white in color and 9/16" wide shall cover the wire helix
- ★ Hose shall be blue and white for increased visibility and safety
- ★ Hose is available in standard sizes of 4- and 5-inch diameter in lengths of 13- 21- and 38-feet
- ★ Other sizes available on request






Architect:	Project Name:
Contractor:	Date:



## MagneGrip Hose Lifting Handle Assembly

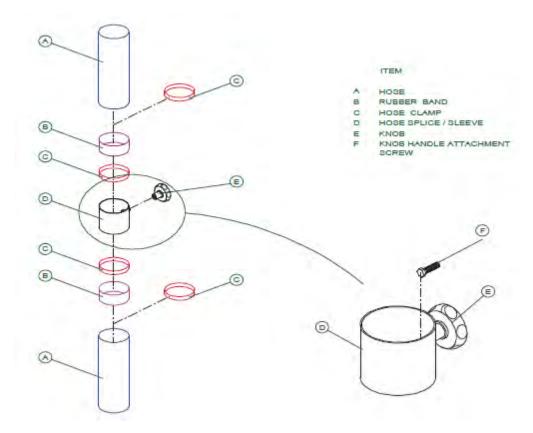

- ★ Manufactured from painted rolled galvanized steel and designed to assist in handling the hose for easy attachment to the Tail Pipe Adaptor
- ★ 4 inch and 5-inch diameter sizes are available





Architect:	Project Name:
Contractor:	Date:



## MagneGrip 850° Lower Exhaust Hose





- ★ Multi-Layer material with spring steel wire helix and multiple layer reinforced construction
- ★ 2 feet long and available 4 inch and 5-inch diameter
- ★ Lower Hose is designed to operate at temperatures up to 850 degrees (F) without failure
- ★ Hose shall be blue in color and UL 94V-0 Flame retardant
- ★ Shall have smooth interior wall for unrestricted airflow





Architect:	Project Name:
Contractor:	Date:



## MagneGrip PRO Nozzle / Tailpipe Adaptor Assembly



- ➤ Boot assembly is 7" diameter and incorporates ambient air inlets in the Flex-Magnet ring with a one-way silicone gasket to allow for cooler air to enter the airstream yet prevent any possible backwash into the bays
- ★ Tailpipe Adaptor body is made from aluminized 12-gauge steel with a low profile 7" diameter nickel plated contact plate
- ★ SS Heavy Duty clamps with 5/16-inch drive for mounting boot to elbow transition
- ★ 90 Deg Elbow Transition is made from 319 cast aluminum and includes a removable debris screen and powder coated reducer to allow use on 4-, 5- or 6-inch hoses





Architect:	Project Name:
Contractor:	Date:



## MagneGrip Auto-Start Exhaust Pressure Sensor



- ★ MPL 500 series pressure sensor, contacts are designed for dry circuit applications
- ★ Terminals for NEMA .020 x .187 male tabs and mate to standard .020 x. 187 female quick connects and 18-22ga wire
- ➤ Pressure Sensor Specifications, body is glass filled polyester, the diaphragm is made from polyurethane with and operating temperature of -40 to 250 degrees and operating pressure of .05in SP H2O
- ★ Mechanical life range above 100,000,000 cycles






Architect:	Project Name:
Contractor:	Date:



## MagneGrip Upblast Backdraft Damper Rain Cap

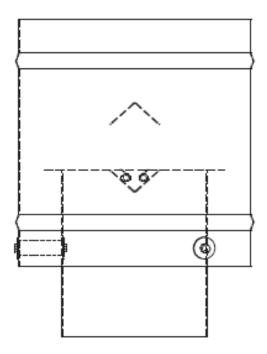

- ★ Standard design, 20ga galvanized steel construction, upblast back draft damper has butterfly damper located inside outer shell for air and water tightness
- ➤ Designed for static free upblast of exhaust gases while including ambient air to help eject exhaust an additional 10-15 feet up and into the prevailing airstream
- ★ Available in 6" to 18" sizes as standard
- ★ Also available in Stainless Steel or custom sizes as required





Architect:	Project Name:
Contractor:	Date:



## MagneGrip Galvanized Spiral Pipe and Fittings




- Requirements for industrial ventilation class #2 (B) gaseous emission control is the category that will generally apply to MagneGrip vehicle exhaust systems
- ★ Spiral pipe, Elbows, fittings, etc. 3" though 8" diameter 24ga
- ★ Spiral pipe, Elbows, fittings, etc. 8.5" though 12" diameter 22ga
- ★ Spiral pipe, Elbows, fittings, etc. over 12.5" diameter 20ga





Architect:	Project Name:
Contractor:	Date:

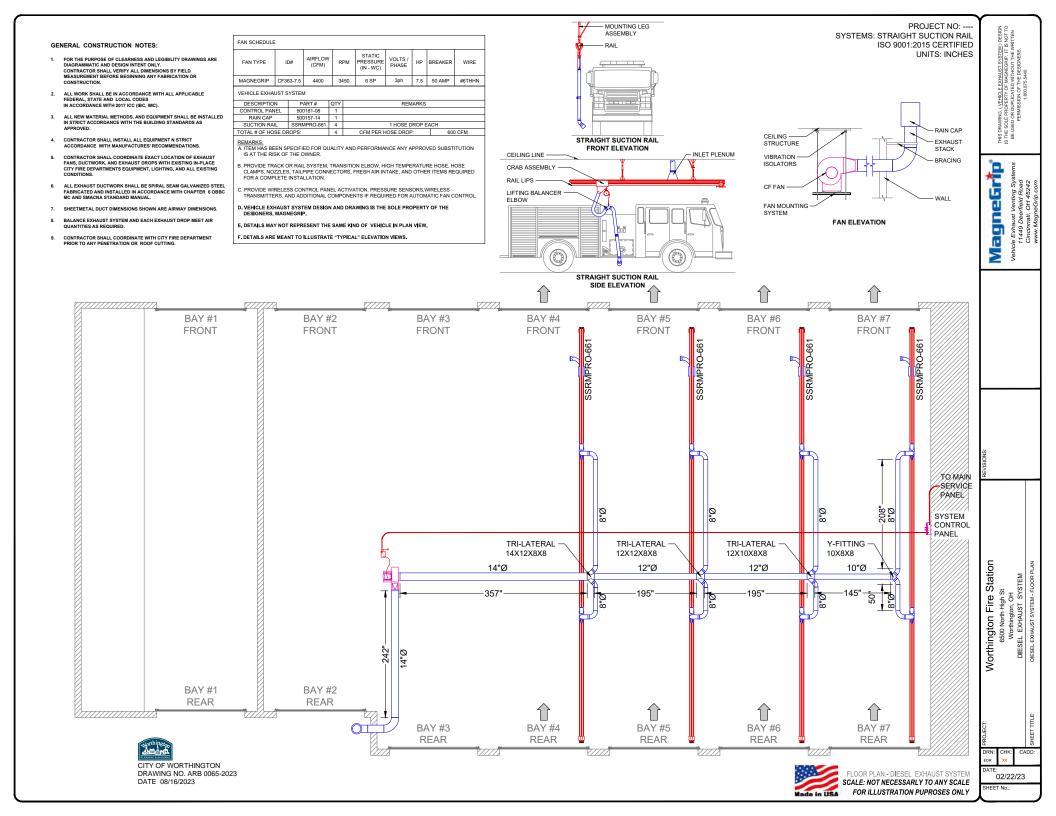



# ARB APPLICATION ARB 0070-2023 38 E. New England Ave.

Plan Type: Architectural Review Board Project: App Date: 08/28/2023

Work Class: Certificate of Appropriateness District: City of Worthington Exp Date:

Status: In Review Completed:

Valuation: \$7,000.00 Approval

Description: small fence on side of house

Parcel: 100-000317 Main Address: 38 E New England Ave Main Zone: AR-4.5(Low Density Apartment Residence


Worthington, OH 43085

Applicant / Owner Michael Shadwick 38 E New England Ave Worthington, OH 43085 Mobile: (513) 532-0538

Invoice No.	Fee		Fee Amount	<b>Amount Paid</b>
INV-00004483	Architectural Review Board		\$7.00	\$7.00
		Total for Invoice INV-00004483	\$7.00	\$7.00
		Grand Total for Plan	\$7.00	\$7.00

## 38 E. New England Ave.



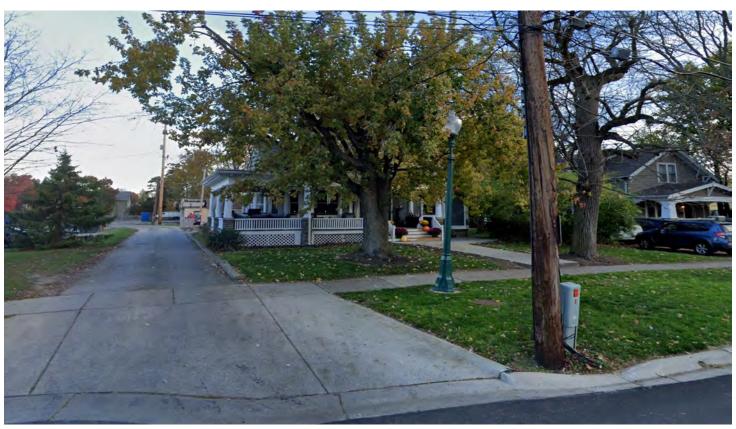

### 38 E New England Avenue

Fence height: 6 feet

Dimensions: 3' x 44' x 15' (including (1) 36" gate

Fence location: (see plot plan – fence marked in yellow)

-Connects to corner of porch and wraps around concrete patio

-Western side (44') is 12" from blacktop driveway

-See photos below of residence for reference

Gate location: (see plot plan – gate marked with X)

-Opening in towards concrete patio Fence rendering: (see image below) -Posts 36" deep in concrete footers

-6' on center

-Materials used: 6x6 treated posts / 1x2's, 1x4's, 1x6's (cedar)







.tt-(2-1010 -, 3151 4)


## Myers Surveying Company, Inc.

2740 Fast Main Street, Columbus 43209 (Bexley), Onto 614-235-8677 FAX: 614-235-4559

A Mortange Engagine Survey respected to: and on Illied to.
1rd Village Title Agency audion Colony Mortgage
Legal Description: Situated in One, Genity of Pranklin, City of Worthington, Being Fast Left 10. Village of Worthington,
Rist Rook Trage 350.

Applicant John & Maureet Coffey III

Posted Address: 38-40 k. New Lughani Ave, West, ingress, OM: F.F. W.A. Flood Zene Designation: Flood Zono 'X' as new (13 M. 3905a) CISH Apparent Eucroschmans: 1) Electron Being Lead by Other for Ingress-Egress

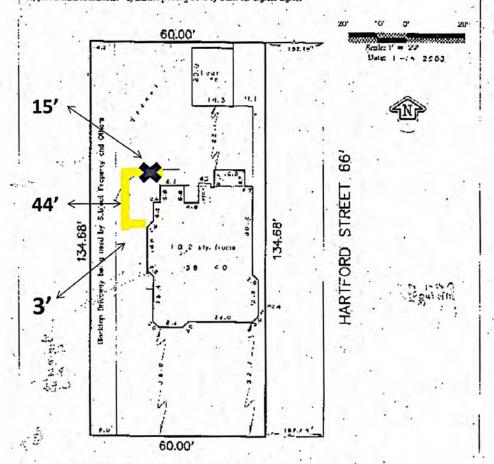

## NEW ENGLAND AVENUE 66'

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DWG # L

Northington

CITY OF WORTHINGTON DRAWING NO. ARB 0070-2023 DATE 08/28/2023



## ARB APPLICATION ARB 0060-2023 940 High St.

07/25/2023

 Plan Type:
 Architectural Review Board
 Project:
 App Date:

Work Class: Certificate of Appropriateness District: City of Worthington Exp Date:

Status: In Review Completed:

Valuation: \$8,000.00 Approval
Expire Date:

**Description:** ANYTIME FITNESS.

NEW CHANNEL LETTER WALL SIGN.

ADD GRAPHICS TO TENANT PANELS ON EXISTING MONUMENT SIGN

Parcel: 100-003941 Main Address: 940 High St Main Zone: C-2(Community Commercial)

Worthington, OH 43085

Applicant Owner

STEVE P MOORE CVS 3407 OH LLC 6060 WESTERVILLE RD. 1 CVS DR #3407-01 WESTERVILLE, OH 43081 Woonsocket, RI 02895

Business: (614) 882-1110 Mobile: (614) 432-5965

Invoice No.	Fee		Fee Amount	<b>Amount Paid</b>
INV-00004283	Architectural Review Board		\$8.00	\$8.00
		Total for Invoice INV-00004283	\$8.00	\$8.00
		Grand Total for Plan	\$8.00	\$8.00

# 940 High St.





# Google Maps



Imagery ©2023 Google, Imagery ©2023 Maxar Technologies, Map data ©2023 Google 20 ft



1 of 1 6/27/2023, 6:32 PM



1 Front Elevation

Scale: 1/4" = 1'-0"



2 Front View

Scale: 3/4" = 1'-0"

3 End View
| Scale: 3/8" = 1'-0"

### Description

A Aluminum Pan Face

1/8" Aluminum Face - (CNC)
Brake Formed Top & Bottom Returns
2" x 2" x 1/8" Aluminum Angle Ends
Paint To Match Existing Monument - TBD

**B** Сору

1ST SURFACE APPLIED NON-ILLUMINATED
DIGITALLY PRINTED WHITE VINYL OVERLAYS
COLOR TO MATCH PURPLE: PMS 2097C (C/W/C)
(NYALA) - CLEAR MATTE LAMINATE
3M Black 220-22 & White 220-20 Matte Vinyl

Project:

Anytime Fitness 926 North High Street Worthington, Ohio 43085

Designer: MF

Quote Number: Q104666-02

Date: 07.19.2023

Rev. 1:

Rev. 2:

Rev. 3:

Rev. 4:

Rev. 4: Rev. 5:



9611 James Ave. S Minneapolis, Minnesota 55431

952 641 9600

archetypesign.com

........................

Contact: Jenny Kruse 952 641 9602 jennyk@archetypesign.com

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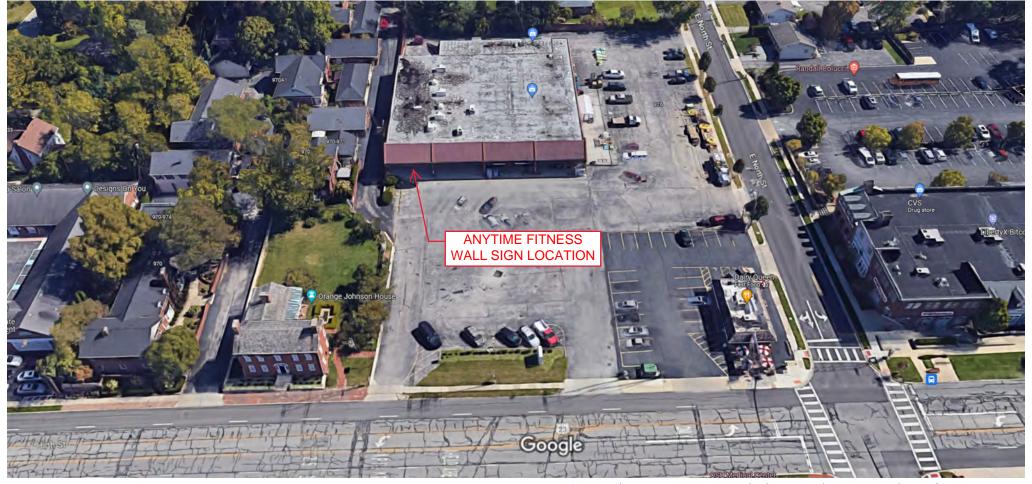
Type:

Description: Tenant Panels

Page: **2.0** 

CITY OF WORTHINGTON DRAWING NO. ARB 0060-2023 DATE 07/25/2023

# Google Maps



Imagery ©2023 Google, Imagery ©2023 Maxar Technologies, Map data ©2023 Google 20 ft

CITY OF WORTHINGTON DRAWING NO. ARB 0060-2023 DATE 07/25/2023

1 of 1 6/27/2023, 6:32 PM



Scale: 3/32" = 1'-0"

### Description

### (A) Channel Letters

3" DEEP STOCK BLACK RETURNS 3/16" WHITE ACRYLIC FACES (7328)(CNC) 1" BLACK TRIMCAP PRE-FINISHED WHITE ALUMINUM BACKS

### B Channel Logo

3" DEEP STOCK BLACK RETURNS 3/16" WHITE ACRYLIC FACES (7328)(CNC) DIGITALLY PRINTED WHITE VINYL OVERLAYS COLOR TO MATCH PURPLE: PMS 2097C (C/W/C) (NYALA) - CLEAR MATTE LAMINATE 1" BLACK TRIMCAP PRE-FINISHED WHITE ALUMINUM BACKS

### © Moniker

3" x 1" ALUMINUM ANGLE RETAINERS - 1/8" ROUTED ALUMINUM FACE PAINTED BLACK (SATIN (1/4" PROJECTION) - SECOND SURFACE TRANSLUCENT WHITE VINYL DIFFUSER

### Illumination

SLOAN PRISM MINI 6500K WHITE LED MODULES 200 L.E.D. MODULES - 78.4 LINEAL FEET TOTAL

(3) - 60C2-60W (701507-60C2) 100-277 VAC 60 Hz - 0.80 A - 60 W @ 12 VDC

### Install

MOUNTED TO WALL USING LAGS

CITY OF WORTHINGTON

DATE 07/25/2023

DRAWING NO. ARB 0060-2023

# archetype

9611 James Ave. S Minneapolis, Minnesota 55431

952 641 9600

### archetypesign.com

Project:

Designer:

Rev. 5:

Anytime Fitness

926 North High Street

Worthington, Ohio 43085

MF Quote Number: Q104666-01

03.25.2023

Rev. 1: 05.31.2023 Rev. 2: Rev. 3: Rev. 4:

Jenny Kruse 952 641 9602 jennyk@archetypesign.com

Approved:

### Type:

Description: Face-Lit Channel Letters w/ Raceway

Page: 1.0

CRITERIA: LANDLORD

Submit for Approval - 126'-1 3/4" x 73' 7 1/2" Leased Width


PROPOSED: 98.71 sa ft

CRITERIA: CITY

SUBMIT FOR APPROVAL

CRITERIA: NTE 1.5 sf of sign area for each lineal foot of leased width

ZONED: C-2 Community Shopping Center

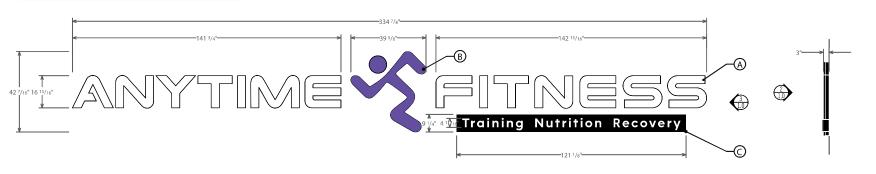


Pront View - Face-Lit Channel Letters

Scale: 3/8" = 1'-0"


Scale: 3/8" = 1'-0"

3 End View

### CHANNEL LETTER (3" DEPTH) FLUSH MOUNTED

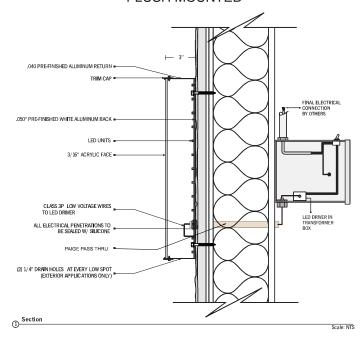

### PUSH THRU CABINET SECTION FLUSH MOUNTED

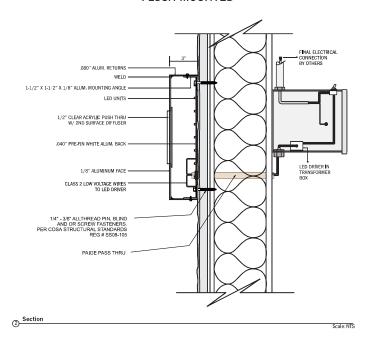

CITY OF WORTHINGTON DRAWING NO. ARB 0060-2023 DATE 07/25/2023

### Project:

Anytime Fitness 926 North High Street Worthington, Ohio 43085

Designer:

Quote Number: Q104666-01

03.25.2023 Date:

Rev. 1: Rev. 2:

Rev. 3: Rev. 4:

Rev. 5:



9611 James Ave. S

952 641 9600

archetypesign.com

Jenny Kruse 952 641 9602 jennyk@archetypesign.com

Approved:

Type:

Description: Face-Lit Channel Letters w/ Raceway

Page: **1.0** 



# **ARB APPLICATION** ARB 0061-2023 691-693 High St.

Architectural Review Board Plan Type:

In Review

Project:

App Date:

07/31/2023

Status:

Parcel:

Work Class: Certificate of Appropriateness

District:

City of Worthington

Exp Date:

Completed:

\$8,000.00 Valuation:

**Approval Expire Date:** 

Description: Signage package for Kittie's bakery and cafe—updating the former Highline Coffee Co. location with

Kittie's branding.

100-000197

Address: 691-693 High St

Main

Zone: C-5(Central Commercial)

Worthington, OH 43085

Applicant Jennifer M Stevens

Diane Herman Business: (614) 992-2899

Owner

Main

Owner Steve Herman

4048 Goose Lane Granville, OH 43023 Mobile: (614) 580-5242

Mobile: (614) 312-3127

Business: (614) 992-2899

Mobile: (614) 312-3127

Invoice No. INV-00004312	Fee Architectural Review Board		Fee Amount \$8.00	Amount Paid \$8.00
		Total for Invoice INV-00004312	\$8.00	\$8.00
		Grand Total for Plan	\$8.00	\$8.00

# 691-693 High St.







# HIGHLINE LOCATION

JULY 31, 2023 V3



# **Current Signage**



Facing High Street





Facing High Street: Entrance on right/bakery on left



North-facing window (towards 161)



View into bakery (door not in use)

# **Our Neighbors**





# **Storefront**

### WINDOW DIMENSIONS:

65wx72h

### **VINYL DIMENSIONS:**

45wx10h

Applied on the interior

### DOOR WINDOW DIMENSIONS:

27wx59h

### VINYL DIMENSIONS:

16wx18w

Applied on the interior







# Building Sign

### KITTIE'S SIGN DIMENSIONS:

90wx15h 2 lavers: blue an

2 layers: blue and white Wood or wood "look"






### **BIRCH SIGN DIMENSIONS:**

84wx24h

100 inches from ground to the bottom of their sign



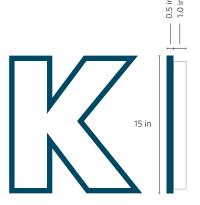

# Wooden Blade Sign





### **EVOLVERIE SIGN DIMENSIONS:**

32wx24h


100 inches from ground to the bottom of their sign



### NOTE:

We'll remove the existing bracket and "sign"



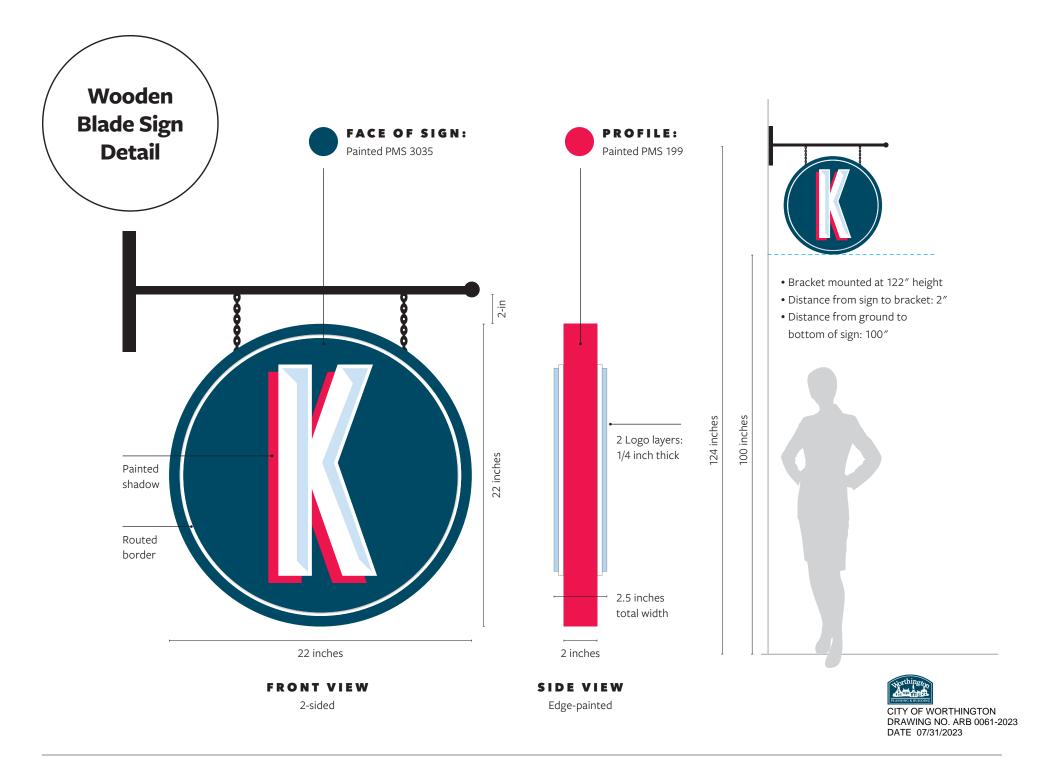

# Promotional Vinyl

**Bakery Windows** 

### WINDOW DIMENSIONS:

37wx72h

### **VINYL DIMENSIONS:**

31wx33h

Applied on the interior









**BAKERY WINDOWS (DETAIL)** 

### NOTE:

These windows look into the bakery/point of sale area of the space. The door is not in use.



# Promotional Vinyl

**Bakery Windows** 

### WINDOW DIMENSIONS:

26wx72h

### 2-SIDED VINYL DIMENSIONS:

12.5wx72h

Applied on the interior







•

RIGHT

Applied on the interior



# North-facing window



WINDOW DIMENSIONS:

127x72

**VINYL DIMENSIONS:** 

70x16

Applied on the interior







@myntegreen





# **ARB APPLICATION** ARB 0064-2023 159-161 E. Granville Rd.

Architectural Review Board Plan Type:

In Review

Project:

App Date:

08/16/2023

Status:

Work Class: Certificate of Appropriateness

District:

**Exp Date:** City of Worthington

Completed:

**Expire Date:** 

\$23.908.00 Valuation:

**Approval** 

Description: Installing vinyl replacement windows to mirror the design of the existing wood

windows. The existing windows are the original wood windows. We are leaving

the existing frame in place and placing our frame and sashes inside the existing

frame.

The style, sizes and profiles match the existing. We are replacing the windows

We changed the sliders to picture windows.

Most of the windows are nonfunctional.

with the same size as existing. The grids will be between the glass.

Main

Address: 161 E Dublin-Granville Rd

Worthington, OH 43085

Main

Zone: R-10(Low Density Residence)

Applicant

Parcel:

Owner **APCO Industries** 

100-000682

Andrew G Silverman 161 E DUBLIN-GRANVILLE RD Amanda Hancock

777 Michigan Ave. Worthington, OH 43085 Columbus, 43215 Mobile: (614) 353-3483

Business: 6142242345

Invoice No. INV-00004475	Fee Architectural Review Board		Fee Amount \$24.00	Amount Paid \$24.00
		Total for Invoice INV-00004475	\$24.00	\$24.00
		Grand Total for Plan	\$24.00	\$24.00

# 159-161 E. Dublin-Granville Rd.






# **2000 DOUBLE HUNG WINDOW**










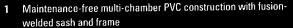



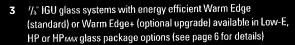


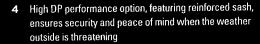

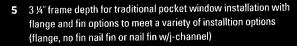





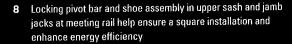

Integral interlock system provides protection against air infiltration and makes window more secure

10 Double weatherstripped sash provides extra protection against dust, dirt and noise

11 Integral lift handles make opening windows easier

12 Extruded aluminum half screen with fiberglass mesh standard; full screen optional

13 Tested and approved to meet NFRC requirements; ENERGY STAR® units available

14 Interior and exterior accessory groove allows for a wide selection of installation options

15 Two ventilation limit latches standard, child safety latches optional

16 Hidden SilLock design with a sloped sill eliminates the need for weep holes, forces water to drain to the exterior of the window, and keeps your windows dry, providing enhanced weather-tight performance











Sleek cam-action sash locks provide security, performance and beauty

High DP Performance option features reinforced meeting rails



Optional child safety vent latch



High DP Performance option features reinforced rails and stiles


latches

Е




# **2000 CONTRACTOR SERIES**



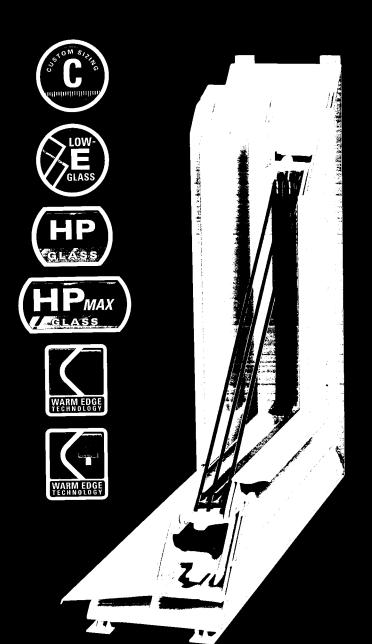

Shown is Contractor 2000 Series double hung corner cut featuring HPMAX glass package upgrade with High DP Performance option.

### **OVERALL FEATURES**

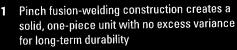



- 2 Warm Edge glass spacer system reduces thermal transfer around the glass perimeter by using a unique U-shaped channel to separate glass panes and interrupt the natural flow of heat to cold; upgrade to Warm Edge+ for enhanced performance
- 3 High DP performance option, featuring reinforced sash on double hung and sliding windows, ensures security and peace of mind when the weather outside is threatening
- 4 Available with Low-E, HP or HPMAX glass package options (see page 6 for details)
- 5 All product styles can be configured to meet ENERGY STAR® requirements in all states
- 6 NFRC rated and certified
- 7 3 ¼" frame depth for traditional pocket window installation
- 8 Designed with equal sight line sash on double hung for traditional wood window appearance
- 9 New Generation uiPVC vinyl never needs painting or caulking and resists conducting heat and cold
- 10 Hidden SilLock design with a sloped sill eliminates the need for weep holes, forces water to drain to the exterior of the window and keeps your windows dry, providing enhanced weather-tight performance







Warm Edge spacer (standard)



Sleek cam-action sash locks on double hung and sliding windows provide security and performance without compromising beauty





## **5100 CASEMENT & AWNING WINDOW**





### **FEATURES**

- 1 Maintenance-free multi-chamber PVC construction with fusion-welded sash and frame
- 2 1/6" IGU glass systems with energy efficient Warm Edge (standard) or Warm Edge+ (optional upgrade) available in Low-E, HP or HP<sub>MAX</sub> glass package options (see page 6 for details)
- 3 ¼" frame depth for traditional pocket window installation
- 4 Interior and exterior accessory grooves provides a wide selection of installation options
- 5 Available right- or left-hand operating
- 6 Sash opens 90° for ventilation and easy cleaning
- 7 Single-handle multi-point locking system
- 8 Awning windows can be combined / mulled / stacked with fixed casement picture windows
- 9 Adjustable hinges
- 10 Full screen with fiberglass mesh
- 11 Tested and approved to meet NFRC requirements; ENERGY STAR® units available

NOTE: This product manufactured in our Toledo, OH facility.









Color-coordinated lock features a sleek low profile that won't interfere with window dressing



Color-coordinated crank handle



Split-arm gear operator on sizes up to 36" x 60". Dual-arm gear operator on larger units



Customer	Silverma	30		Sales rep	JIK	CE	Year	1342
Manufacturer Ply 6	2000	Interior Colo				Exterior Color White		Screens 72
Caulk	Coil	Foam	RWD	NO Type of Removal		Exte	rior Siding	



Let's Make Plans.

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	Location	Transferration and industrial and a few particular and a few particular and the contract of th	A de Art at 12 land to them sty I that We .	and the fact that the first that the	Rough Opening				Notes	
<b>V</b>	Front 161	DH	HP	Lyks.	26×64	llels Lel	13/8			
14	Frent 161	D/t	149	410	34.64	461/8 6	(3/8)			
13/	" 161	1,	21	15e	20 × 64	16/18 61	l 3/8			
4	169	L/	· . L/	dete	16×64	19% (	13/8	·		
18	, 169	e,	٠,	Mined	40×64	34 6	13/8	-	·	
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6	Lest Bay 161	ι,	ι,	34	7	28 x 61				
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12	LS7 161	sliding	٠,	( V	58 = 26	5244 × 2.3	3/8			
גיו	Risht 169	٤,	ι,	64	٠,	5214 x 23	31/8	·		·
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VE	" 169	1,	"	31	29 = 64	28 + 61	3/8		Worthington	
V	Right list	,,	//	31	29 × 64	28461	3/8		CITY OF WORTH	ARB 0064-2023

DRAWING NO. ARB 0064-2023 DATE 08/16/2023

Ander Ander	Silver	4 ^		Sales rep	INCE	Year built .	
Manufacturer Plyber	2600	Interior Co	lor Whil	re	Exterior Color Whoke	Screens	1/2
Caulk	Coil	Foam	RWD	Nead Typ	pe of Removal	Exterior Siding	

[]APCO

Let's Make Plans.

DATE 08/16/2023

		GRID	PATT	ERN	TO BE D	ETERMINGO	<b>D</b>	and the management of the special section of
	Location	iStyle/Tiype	Glass	Grids	Rough Opening	Make!Size	CL 1 P. E.S. POLICE TO BURGE LIBERTH BURGES IN A CONTROL OF	Notes
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30	2 nc Flear Rouris	ι,	1.	3V	₽.	28 x 613/2		
31	, 169	٠,		IV	16 + 64	16/8 + 613/8		
B2	/ '' [69]	1,	.: <b>8</b> /	40	40 × 64	4018 + 613/8		
P3	11 169	11	١,	IV	16×64	16/8 + 613/8		Worthington
34	" 169	2 /	L C	V3V	20264	28/81613/8 B	ath	CITY OF WORTHINGTON
Р	age <u>2</u> of <u>2</u>		, ,	•	•	· <i>U</i>		DRAWING NO. ARB 0064-2023



# **ARB APPLICATION** ARB 0066-2023 2151 W. Dublin-Granville Rd.

Architectural Review Board 08/22/2023 Plan Type: Project: App Date:

Exp Date: Work Class: Certificate of Appropriateness District: City of Worthington

Completed: Status: In Review Approval Valuation: \$1,887.00

**Expire Date:** Description: New sandblasted dimensional logo on backer board. Backer board to have vinyl lettering for

Restaurant Bar. Black backer with white text

100-003920 Main Main Address: 2151 W Dublin-Granville Rd Zone: C-2(Community Commercial) Parcel:

Worthington, OH 43085

Owner Applicant 161 LINWORTH PROPERTIES LLC **Great Impressions Signs** 2145 W DUBLIN-GRANVILLE RD Greg Kitzmiller

Worthington, OH 43085 Business:

3800 Agler Road (614) 929-8970 Columbus, OH 43219 Business: 614-428-8250 Mobile: 614-348-4731

Invoice No. INV-00004460	Fee Architectural Review Board		Fee Amount \$2.00	Amount Paid \$2.00
		Total for Invoice INV-00004460	\$2.00	\$2.00
		Grand Total for Plan	\$2.00	\$2.00

# 2151 W. Dublin-Granville Rd.





### Rodos Greek Taverna

### **DESCRIPTION:**

Wood grain painted HDU with routed/blasted Rodos logo + Restaurant Bar in white hi performance vinyl





 $\star$   $\star$   $\star$  DUE TO THE PRINTING PROCESS OR COMPUTER MONITORS, COLORS IN PROOF MAY NOT BE 100% ACCURATE  $\star$   $\star$   $\star$ 



_					
MJ	JOB NAME: -			CUSTOME	R APPROVAL:
IVIJ	CONTACT: -				
SALES REP	JOB LOCATION: -			(X)	
GK	ORDER #: XXXX	LINE ITEM: -	DATE: -	Customer Signature	Date

# Rodos Greek Taverna **DESCRIPTION:** PVC - flush to wall PVC letters - stud mount WALL 1/4" THREADED STUD RIVET NUT W/ SILICONE Stud Mounted And Silicon Sealant 2.5" studs 3/16" All Thread 1/2" PVC letters Stud Mounted And Silicon Sealant 3/16" All Thread Wood siding wall





# ARB APPLICATION ARB 0068-2023 70 W. North St.

Architectural Review Board 08/25/2023 Plan Type: Project: App Date:

Exp Date: Work Class: Certificate of Appropriateness District: City of Worthington

Completed: Status: In Review

**Approval** \$100,000.00 Valuation: **Expire Date:** 

Description: One-story bedroom addition (182 sf) over crawl space to rear (north) side of existing two-story

house. 14'-4" wide x 12'-8" deep.

100-000721 Main Main Parcel: Address: 70 W North St Zone: R-10(Low Density Residence)

Worthington, OH 43085

Owner Contractor Applicant Neil Gant Glen Sullivan Steven Schwope 70 W NORTH ST 6296 PROPRIETORS RD Worthington, OH 43085 Worthington, OH 43085 Home: 6147811426

Mobile: 6143547621 Mobile: 6145707304

886 Critchfield Rd Columbus, OH 43213 Business: 6148461305 Business: 6145458605

Invoice No. INV-00004474	Fee Architectural Review Board		Fee Amount \$100.00	Amount Paid \$100.00
		Total for Invoice INV-00004474	\$100.00	\$100.00
		Grand Total for Plan	\$100.00	\$100.00

# 70 W. North St.









CITY OF WORTHINGTON DRAWING NO. ARB 0068-2023 DATE 08/25/2023



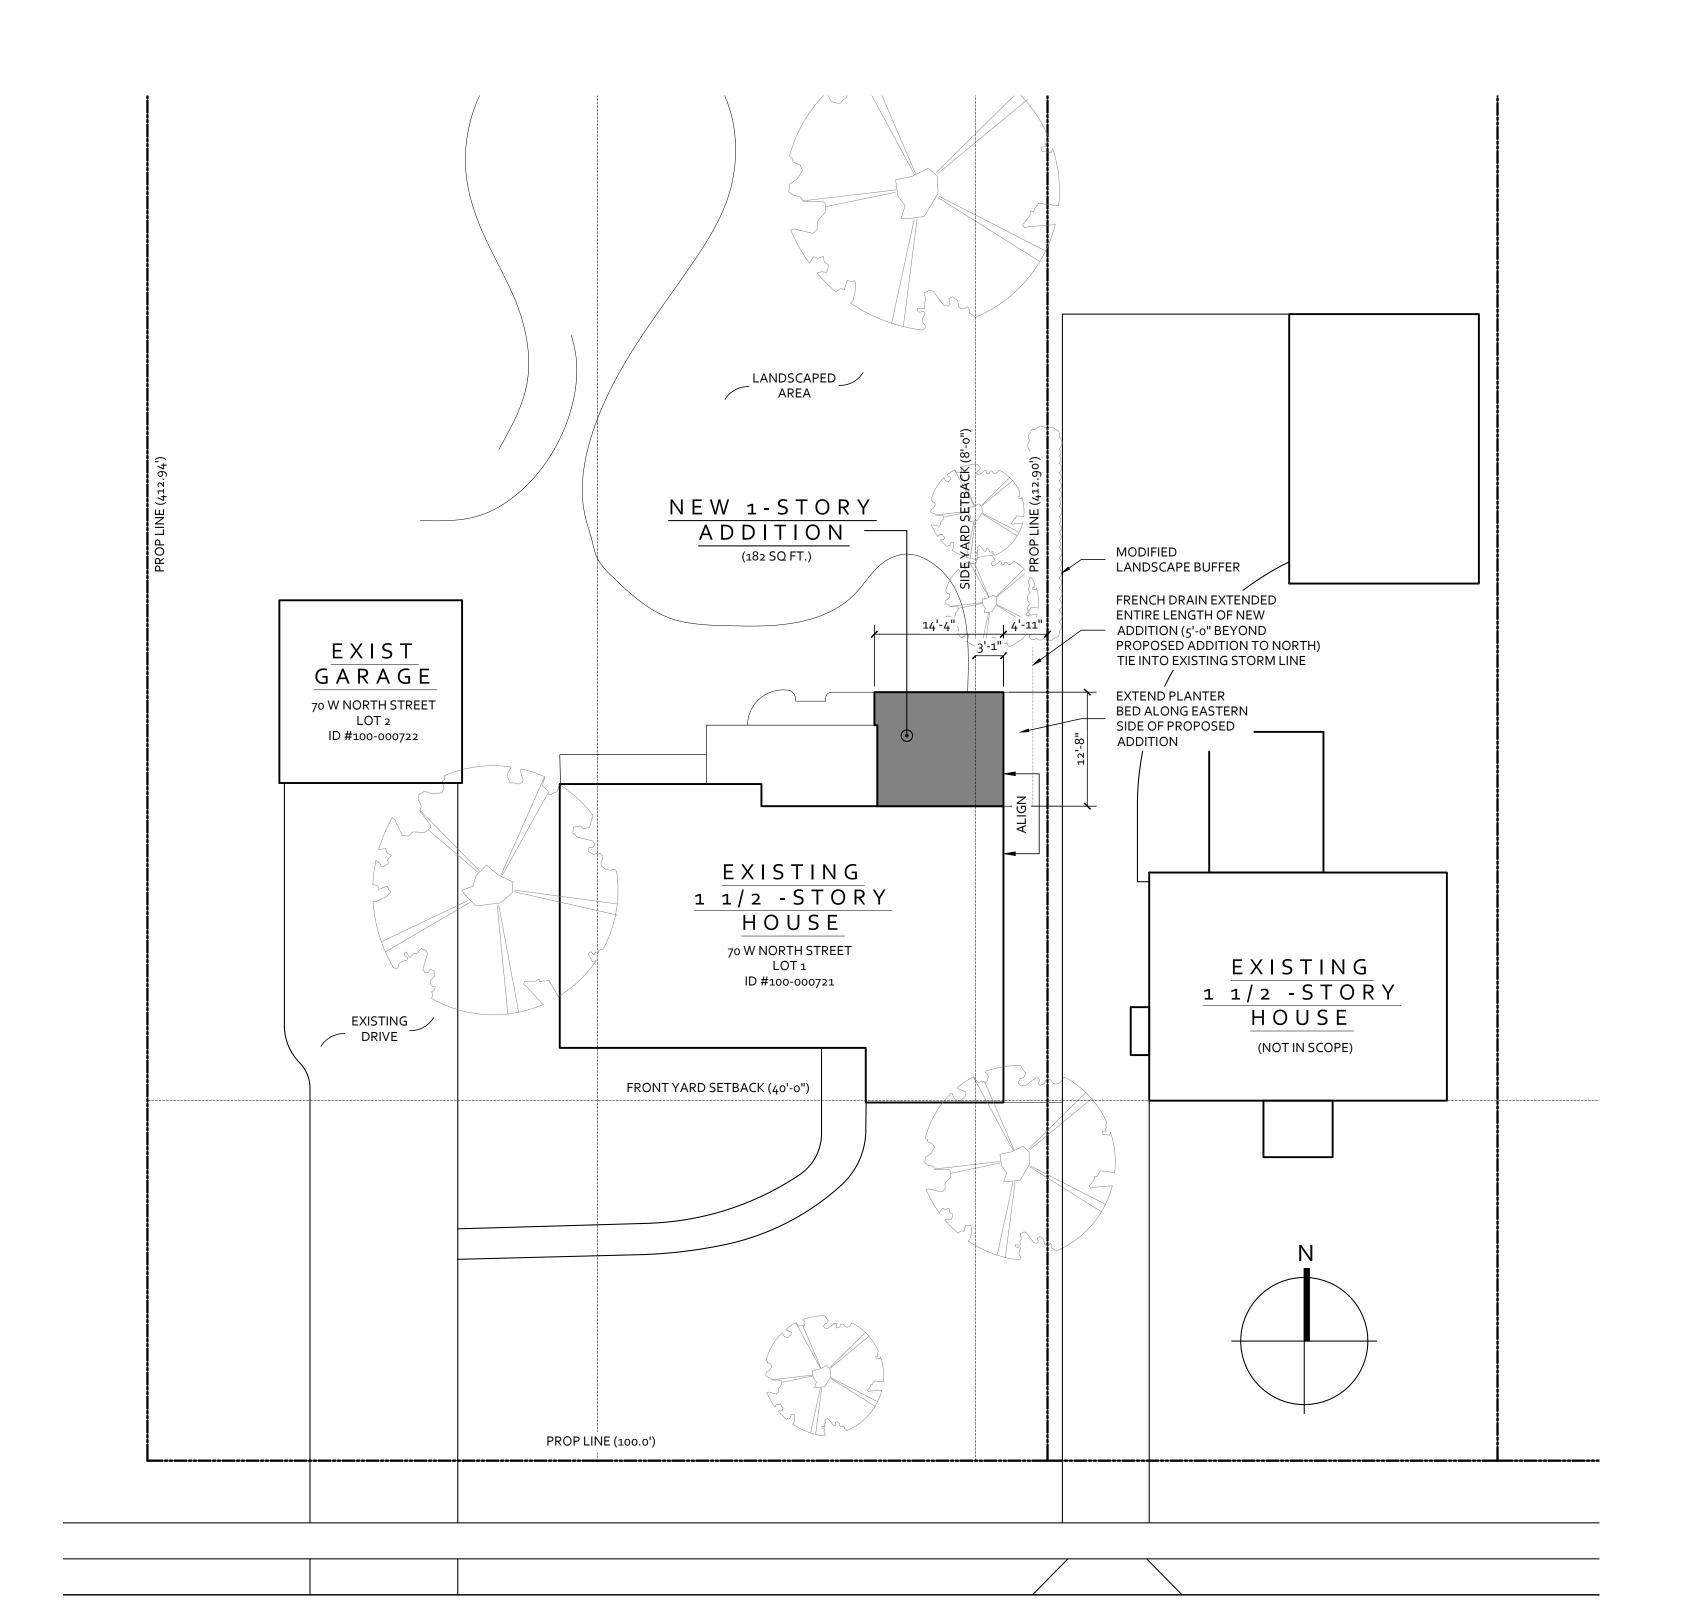

# NORTH STREET

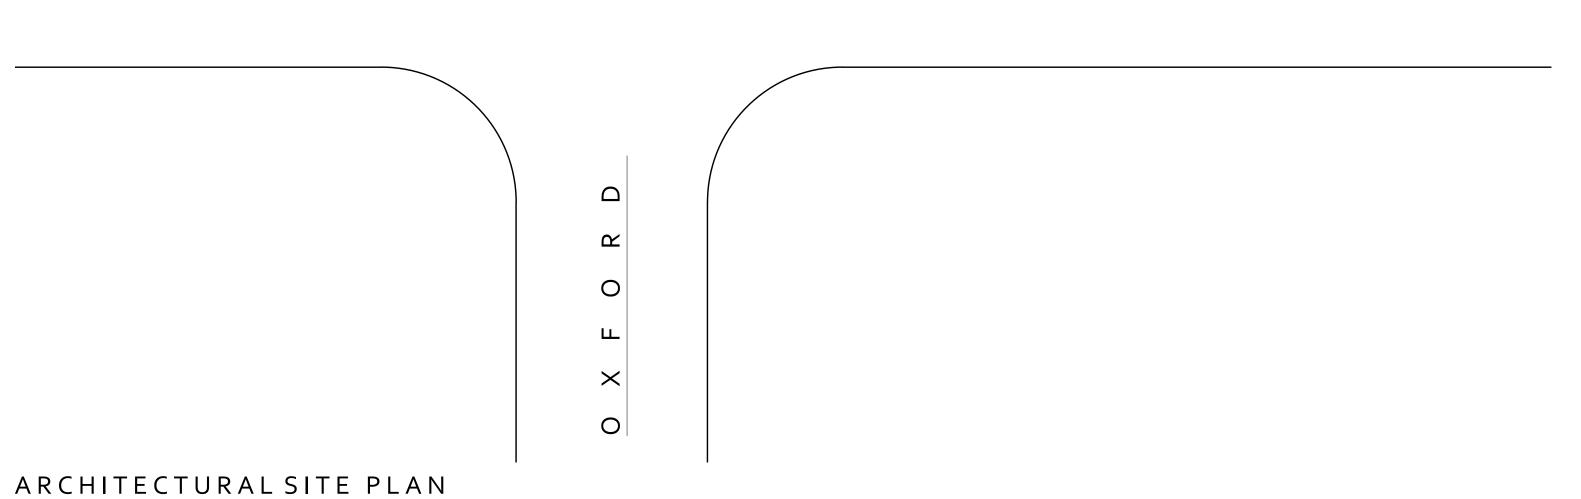



886 CRITCHFIELD ROAD COLUMBUS, OHIO 43213 schwopearchitecturestudio.com

ALL DRAWINGS AND CONTENT ARE AND SHALL REMAIN THE PROPERTY OF SCHWOPE ARCHITECTURE STUDIO, LLC. USE IS PROHIBITED WITHOUT CONSENT FROM SCHWOPE ARCHITECTURE STUDIO, LLC

# $\infty$

DATE: 08/25/2023 PLANNING & ZONING ISSUE

PROJECT NUMBER: DRAWN BY:


70 WEST NORTH STREET WORTHINGTON, OHIO 43085

23-0019 SPS

ARB ISSUE SET 08/25/2023 BZA ISSUE SET

> ARCHITECTURAL SITE PLAN



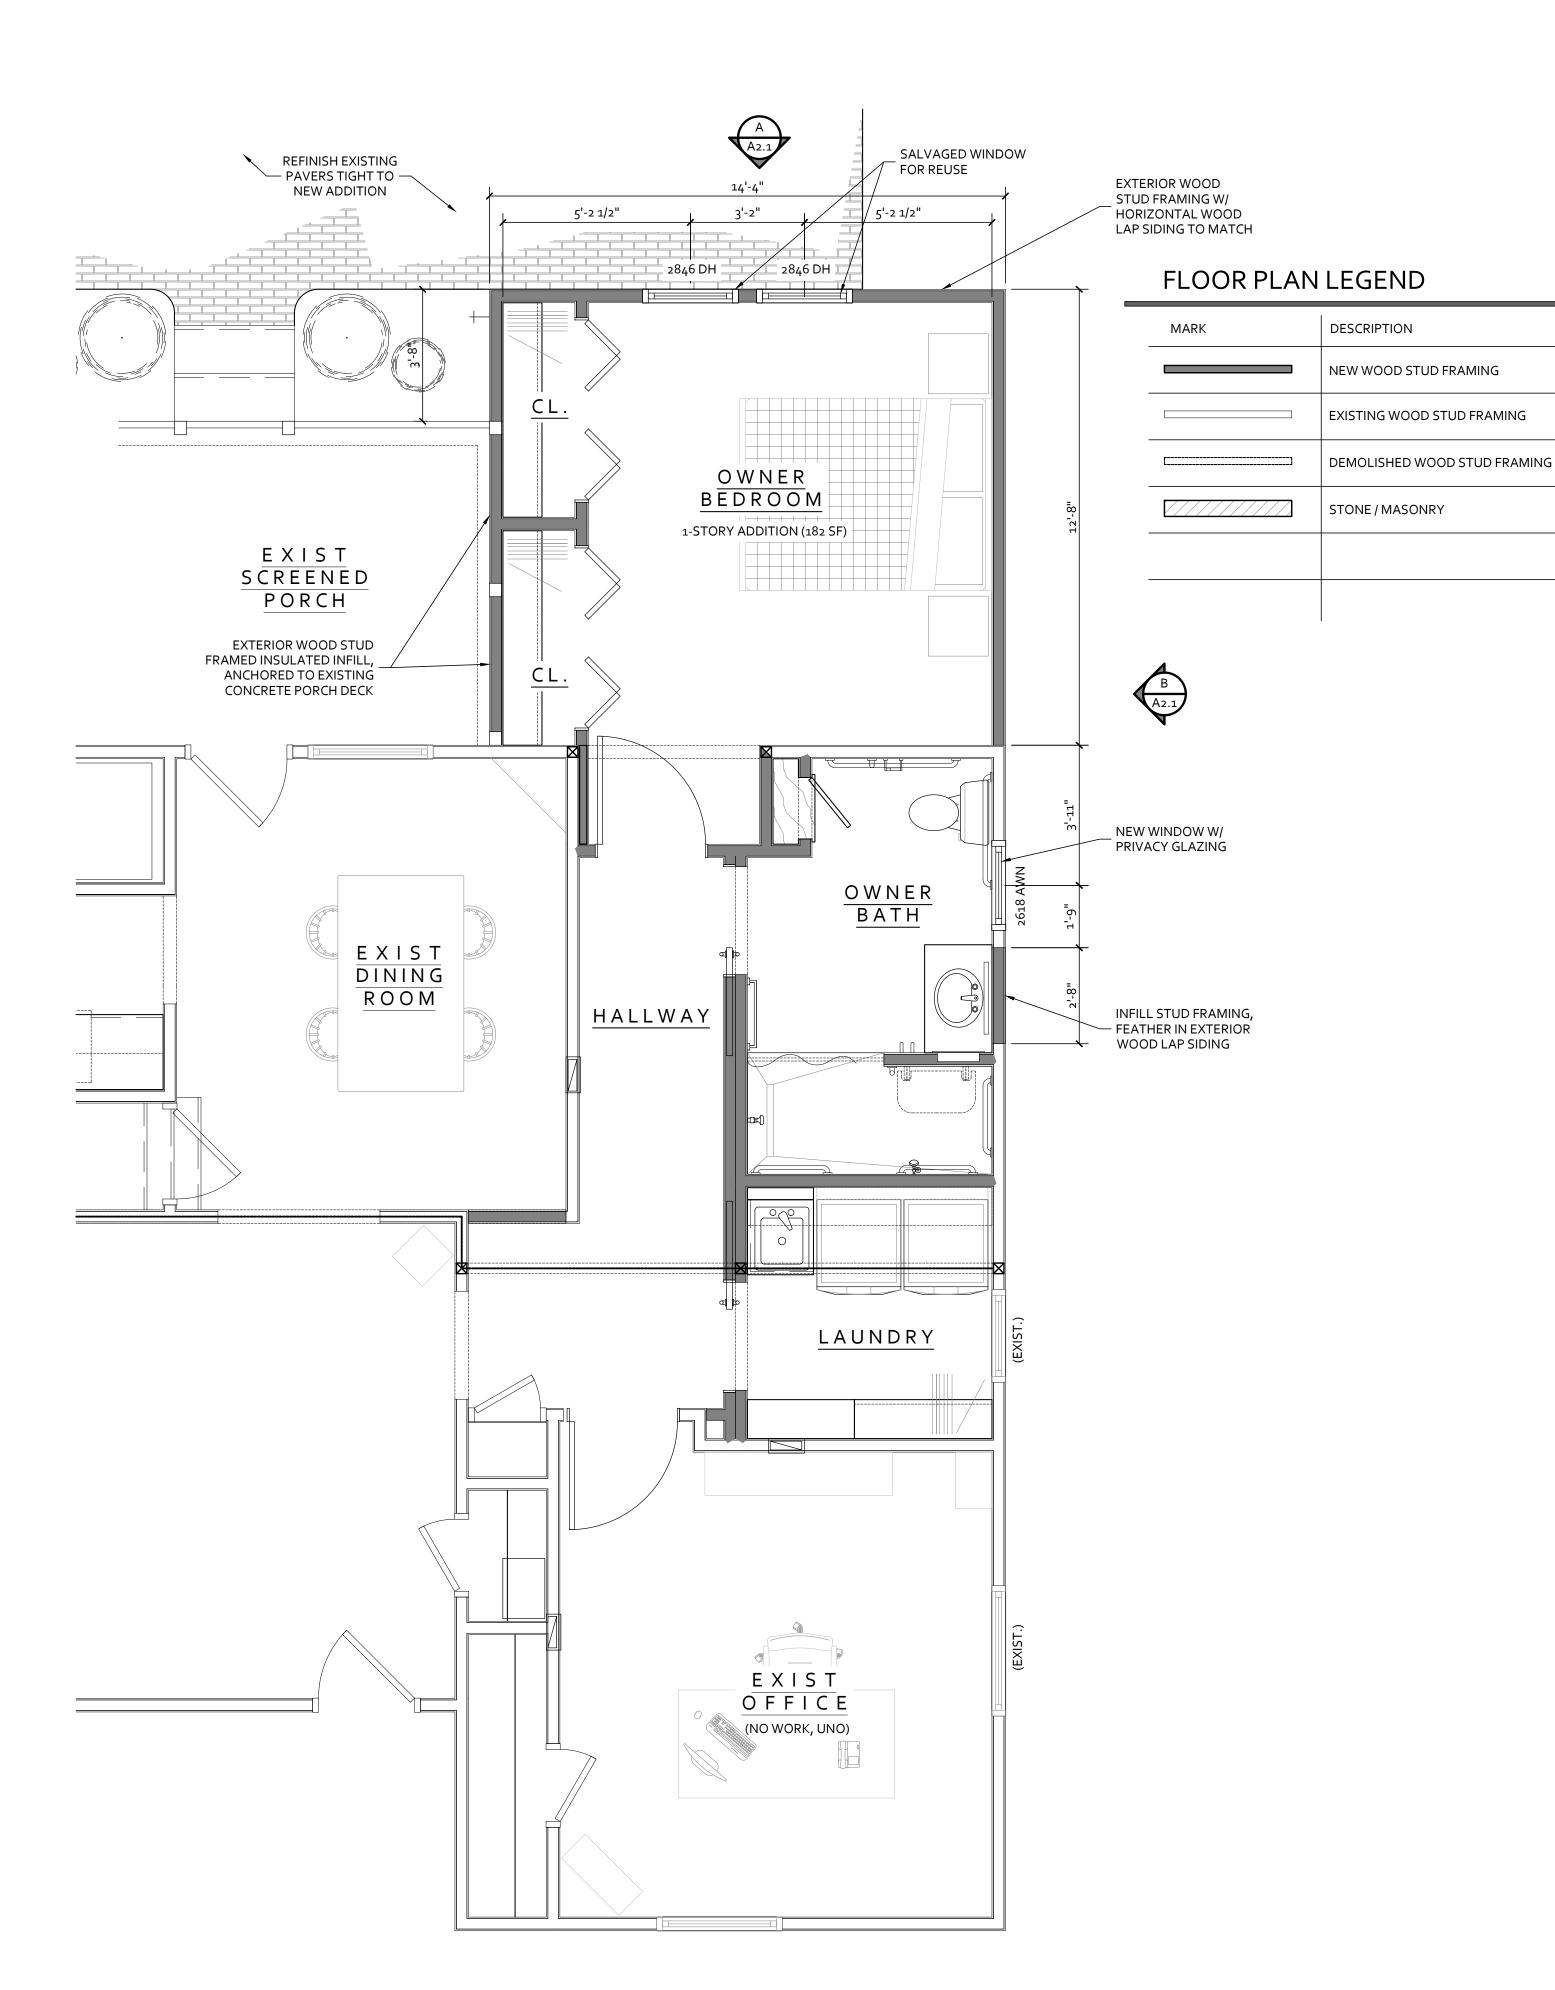



886 CRITCHFIELD ROAD COLUMBUS, OHIO 43213 schwopearchitecturestudio.com

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# 8

3085

23-0019 SPS

PROJECT NUMBER: DRAWN BY: DATE: 08/25/2023

PLANNING & ZONING ISSUE

ARB ISSUE SET 08/25/2023 BZA ISSUE SET

> FLOOR PLAN & NOTES

CITY OF WORTHINGTON DRAWING NO. ARB 0068-2023 DATE 08/25/2023

886 CRITCHFIELD ROAD COLUMBUS, OHIO 43213 schwopearchitecturestudio.com


ALL DRAWINGS AND CONTENT ARE AND SHALL REMAIN THE PROPERTY OF SCHWOPE ARCHITECTURE STUDIO, LLC. USE IS PROHIBITED WITHOUT CONSENT FROM SCHWOPE ARCHITECTURE STUDIO, LLC




# EXTERIOR ELEVATION - REAR (NORTH) EXISTING SCALE: 1/4" = 1'-0"



EXTERIOR ELEVATION - SIDE (EAST) EXISTING SCALE: 1/4" = 1'-0"

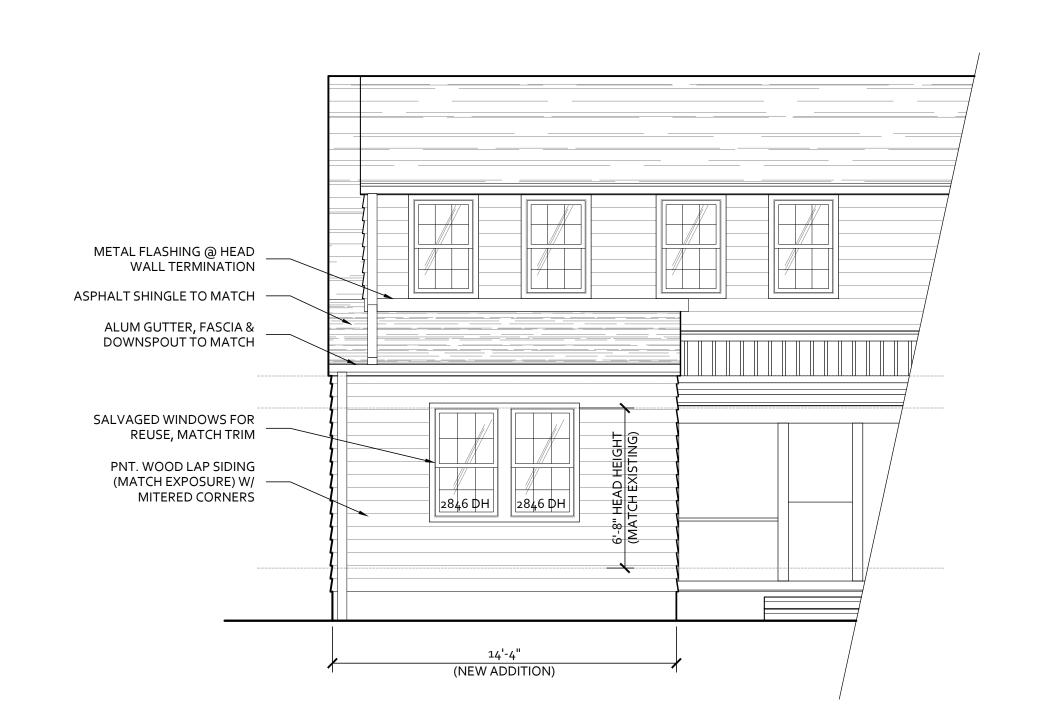



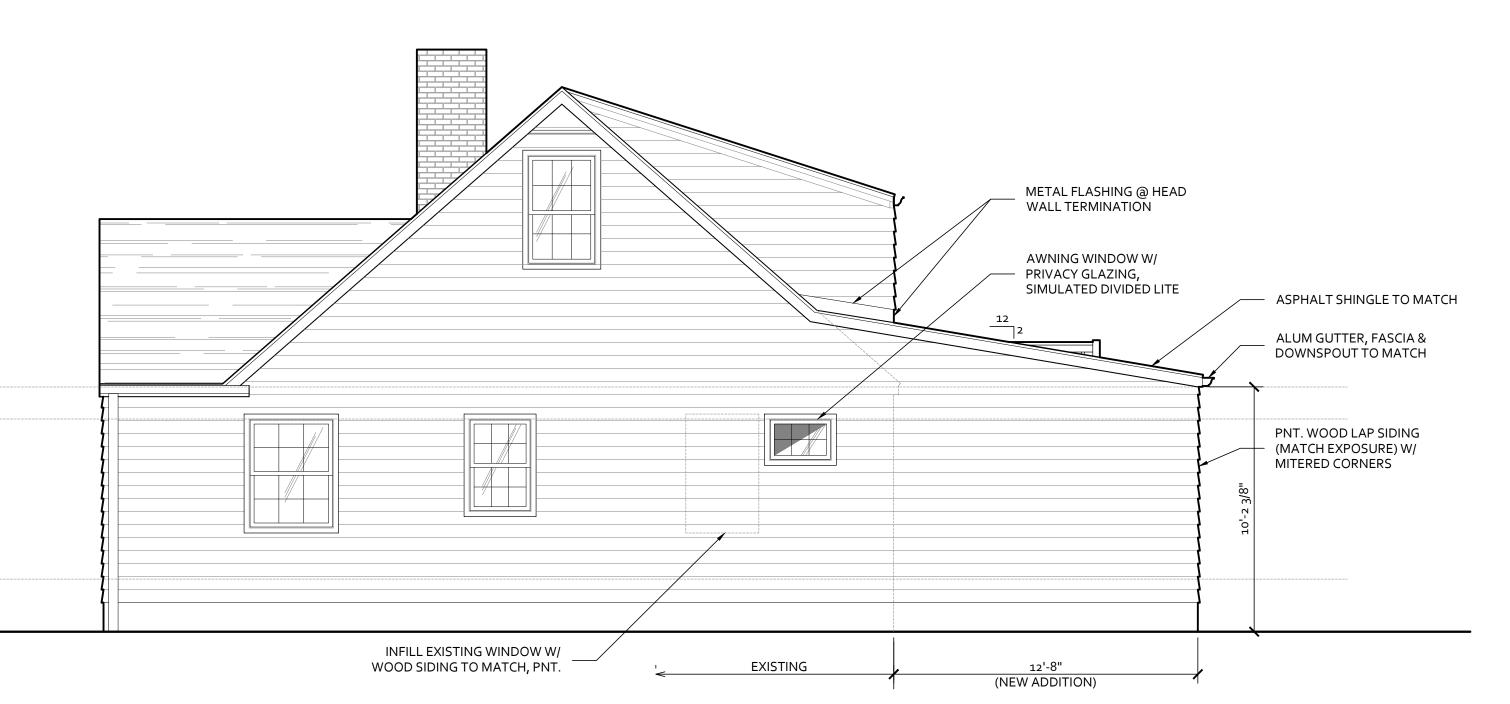

CITY OF WORTHINGTON DRAWING NO. ARB 0068-2023 DATE 08/25/2023

 $\infty$ REMO

23-0019 SPS DRAWN BY: DATE: 08/25/2023

PROJECT NUMBER:

PLANNING & ZONING ISSUE

ARB ISSUE SET 08/25/2023 BZA ISSUE SET

> **EXTERIOR ELEVATIONS**

A2.1



### ARB APPLICATION ARB 0069-2023 100 W. Granville Rd.

Plan Type: Architectural Review Board Project: App Date: 08/28/2023

Work Class: Certificate of Appropriateness District: City of Worthington Exp Date:

Status: In Review Completed:

Valuation: \$900,000.00 Approval
Expire Date:

**Description:** ew siding, windows, garage doors, new covered brick front porch, mudroom addition, and second

story addition over existing addition on rear of home. New stamped concrete patio.

 Parcel:
 100-000062
 Main
 Address:
 100 W Dublin-Granville Rd
 Main
 Zone:
 R-10(Low Density Residence)

Worthington, OH 43085

Applicant Owner Applicant Owner

Element One Erin Turnock Bryce Jacob Kolby Turnock

Courtney Bowe 100 W DUBLIN-GRANVILLE RD 4443 N High St 100 W DUBLIN-GRANVILLE RD

4443 N. High St. Worthington , OH 43085 Columbus, OH 43214 Worthington , OH 43085

Columbus, OH 43214 Business: (614) 296-9534

 Invoice No.
 Fee Amount Paid

 INV-00004467
 Architectural Review Board
 \$200.00

 Total for Invoice INV-00004467
 \$200.00

 Grand Total for Plan
 \$200.00

# 100 W. Granville Rd.





# Structural Notes; Comply with 2019 Residential Code of Ohio

- 1) Dimensional lumber used for all framing, Spruce-Pine-Fir #2 or better; unless otherwise noted
- 2) All headers shall be 2 2x12 with 1/2" plywood or OSB spacer, supported by 3" minimum bearing each end; unless otherwise noted
- 3) All framing shall align throughout the structure as to create a continuous load path from the roof to the foundation
- 4) Roof assemblies which are subject to wind uplift pressures of 20 pounds per square foot or greater shall have roof rafters or trusses attached to their supporting wall assemblies by connections capable of providing the resistance required in Table 802.11
- 5) Sheathing on exterior walls to align with face of foundation
- 6) All lumber in contact with concrete, masonry or earth to be pressure treated
- 7) Double floor joists under walls parallel to joist direction
- 8) Exterior dimensions shown to face of sheathing or face of foundation, interior dimensions shown to face of framing
- 9) Door and windows sized noted in feet/inches, e.g. 2668 = 2'-6" x 6'-8"
- 10) Contractor to provide all means of temporary support, scaffolding, bracing, shoring or guying in order to insure stability during construction
- 11) Fireblocking shall be provided to cut off all concealed horizontal or vertical draft openings
- 12) Final locations and sizing of HVAC registers and supply & return ducting provided by HVAC contractor
- 13) Truss design by truss manufacturer
- 14) Gas and/or wood burning insert fireplace clearances and installation per manufacturers instructions
- 15) All work associated with asbestos, radon, mold abatement or exterminating, if required, is by others under a separate agreement
- 16) All windows noted "Egress" meet minimum net clear opening of 5.7sf (5.0sf for grade floor) and a sill not more than 44 inches above the floor
- 17) Attic access, where required, to be 22"x30" minimum with 30" minimum clearance above
- 18) Crawl access to be 24"x16" minimum when through a perimeter wall
- 19) Garage floor surfaces shall be 3,500psi concrete, sloped toward the main overhead door
- 20) Enclosed accessible space under stairs shall have walls, under-stair surface and any soffits protected on the enclosed side with 1/2" drywall
- 21) Cuts, notches and holes bored in trusses, structural composite lumber, structural glue-laminated members or I-joists are prohibited except where permitted by the manufacturer's recommendations or where the effects of such alterations are specifically considered in the design of the member by a registered design professional 22) Finished grade shall fall a minimum of 6" within the first 10' from building perimeter
- 23) Footings to bear on undisturbed soil or engineered compacted fill
- 24) Minimum footing size: 8" wall, 16" wide 8" deep; 10" wall, 18" wide 8" deep; 12" wall, 20" wide 8" deep
- 25) All concrete to of minimum compressive strength per Table 402.2
- 26) Foundation anchorage shall be 1/2" bolts spaced maximum of 6 feet on center and within 12" of each plate section. Bolts shall extend a minimum of 7 inches into concrete or grouted cells of concrete masonry units
- 27) Bath fans vent to the exterior
- 28) Exhaust hood and/or ducting installed per manufacturers instructions
- 29) Solid blocking 16" o.c. between bandboard and first parallel floor joist, align with wall layout
- 30) Building elements and structural wood panels fastened per Table 602.3 (1) & 602.3 (3)

# Climatic and Geographic Design Criteria

Ground Snow Load	Wind Speed	Seismic Conditions	Subject to Da	amage From	Frost Depth	Maximum allowable assumed
lb/sf	mph		Weathering	Termite		soil bearing pressure
20	115	В	Severe	Moderate to Heavy	36"	1500psf

### Smoke & Carbon Monoxide Detectors

Smoke detectors shall be listed in accordance with UL 217 and installed in accordance with NFPA 72 and in all sleeping rooms, area outside, adjacent and within 15 ft. of each sleeping room. They shall also be located on each story including basement and cellars and all detectors shall be hardwired, interconnected utilizing photoelectric and ionization technologies.

Alterations, repairs and additions in existing dwellings, the entire dwelling shall be equipped with smoke detectors as required for new dwellings. The new detectors are not required to be interconnected unless remodeling requires removal of appropriate wall and ceiling coverings. In areas where remodeling does not take place allowing accessibility, then detectors in those areas may be battery powered.

Carbon Monoxide detectors shall be installed outside of each separate sleeping area in the immediate vicinity of the bedrooms in dwellings with fuel-fired appliance or attached garages. Single station alarms shall be listed as complying with UL 2034 and installed per this code & manufacturers instructions.

# Insulation and Fenestration Requirements

Climate Zone	Fenestration U-Factor	Skylight U-Factor	Ceiling R-Value	Wall R-Value	Mass Wall R-Value	Floor R-Value	Basement Wall R-Value	Slab R-Value, Depth	Crawl Wall R-Value
5	.30	.55	49	20 or 13 + 5	13/17	30	10/13	10, 2ft.	10/13

### MORTGAGE LOCATION SURVEY

TITLE CO. FILE NO.: 12-14968

43085

Turnock

Erin T

and

<u>jalo</u>

Date:

8-21-23

Revisions:

Ø

8

TITLE COMPANY: NORTHWEST SELECT TITLE AGENCY, LLC LENDER: FIRST COMMONWEALTH BANK ERIN L TURNOCK AND KOLBY C. TURNOCK

SELLER: MOLLY M. KOCH AND SHARNEY J. KOCH 04/30/2023

ORDER NO.: 0425-23


PARCEL NO : 100-000062-00

LEGAL DESCRIPTION: BEING LOT 5 AND PART OF LOT 6 OF HENRY T. FAY'S SUBDIVISION, OF RECORD IN PLAT BOOK 4, PAGE 258, FRANKLIN COUNTY



APPARENT ENCROACHMENTS: NONE

IME CERTIFY THAT IME HAVE EXAMINED THE SURVEY FOR SCALE: 1"=30"

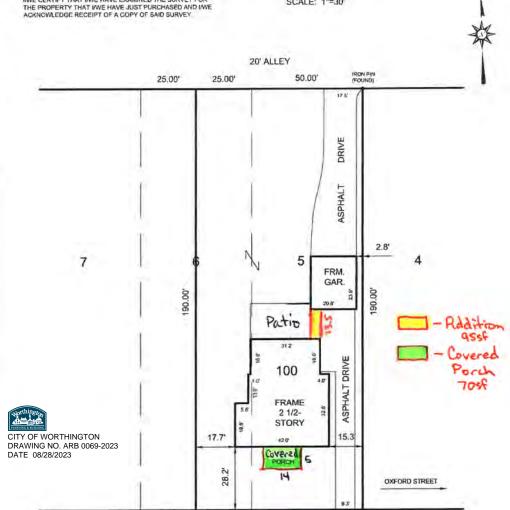

WEST DUBLIN GRANVILLE ROAD (99')

25.00

25.00



P.O. Box 1902 rville, Ohio 43086-1902

Phone: (614)378-9140


We hereby certify that the foregoing MORTGAGE LOCATION SURVEY was prepared in a Administrative Code and is not a boundary survey pursuant to Chapter 473-37 Ohio Admi mortgage toon and tile purposes only and does not show the location of fences or landscid


50.00



Approval:

Page:

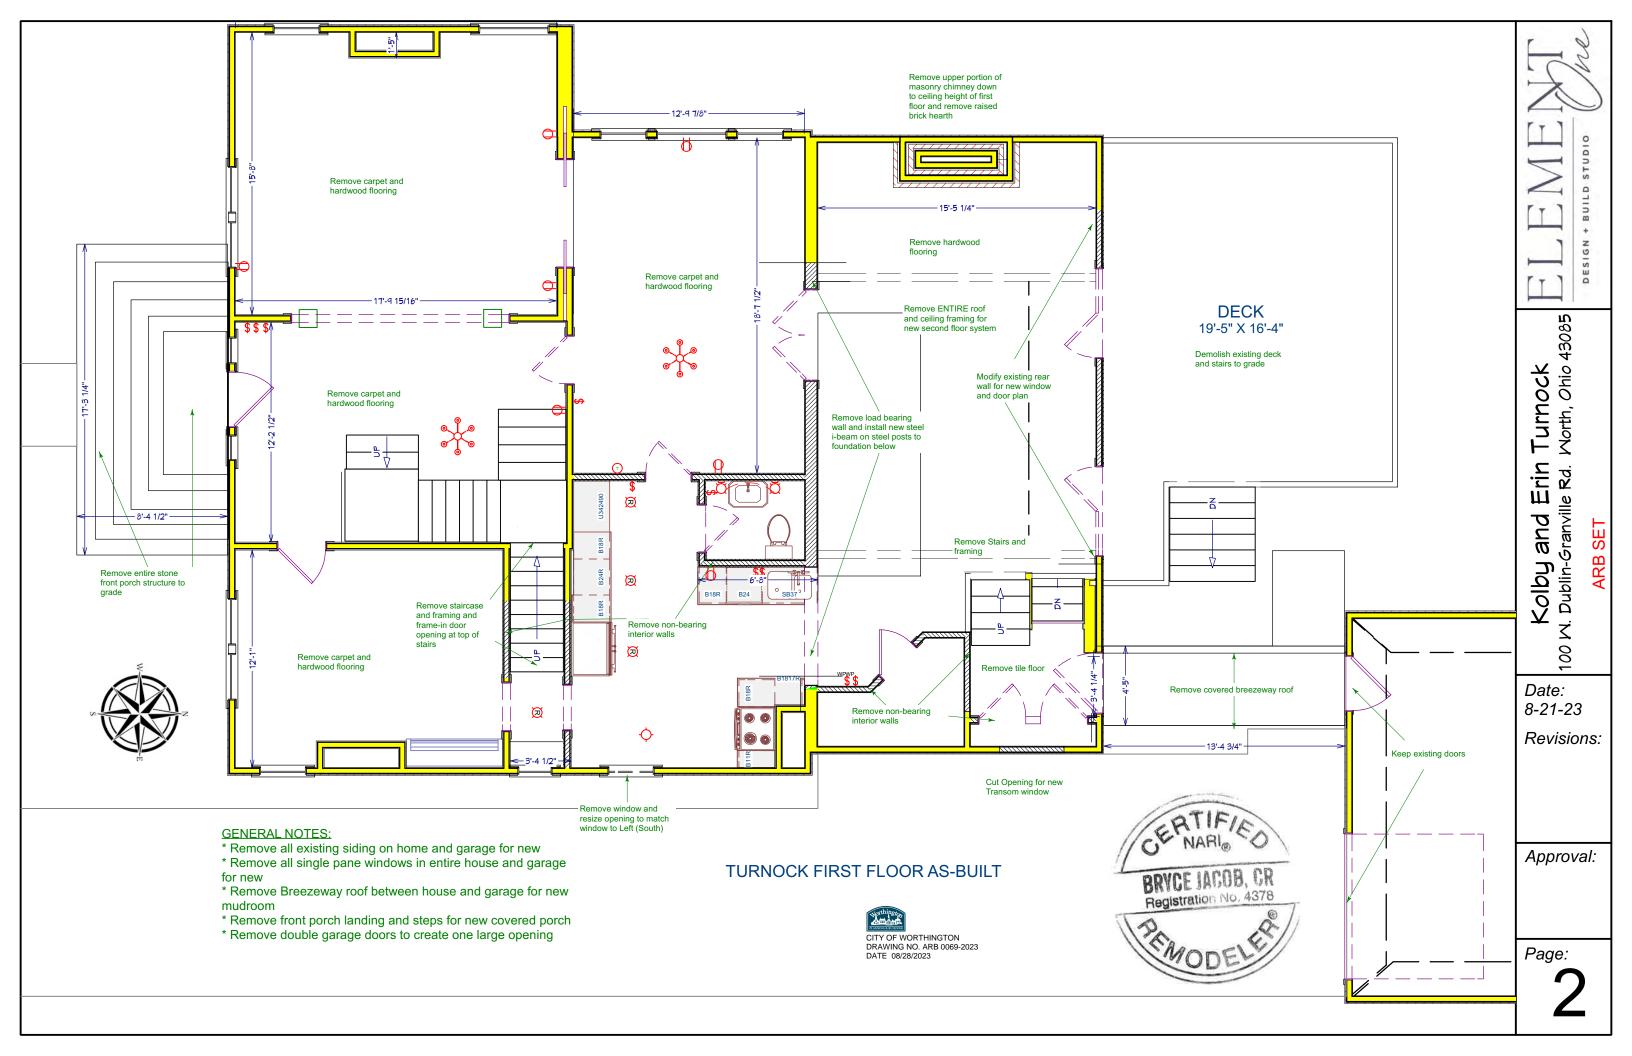

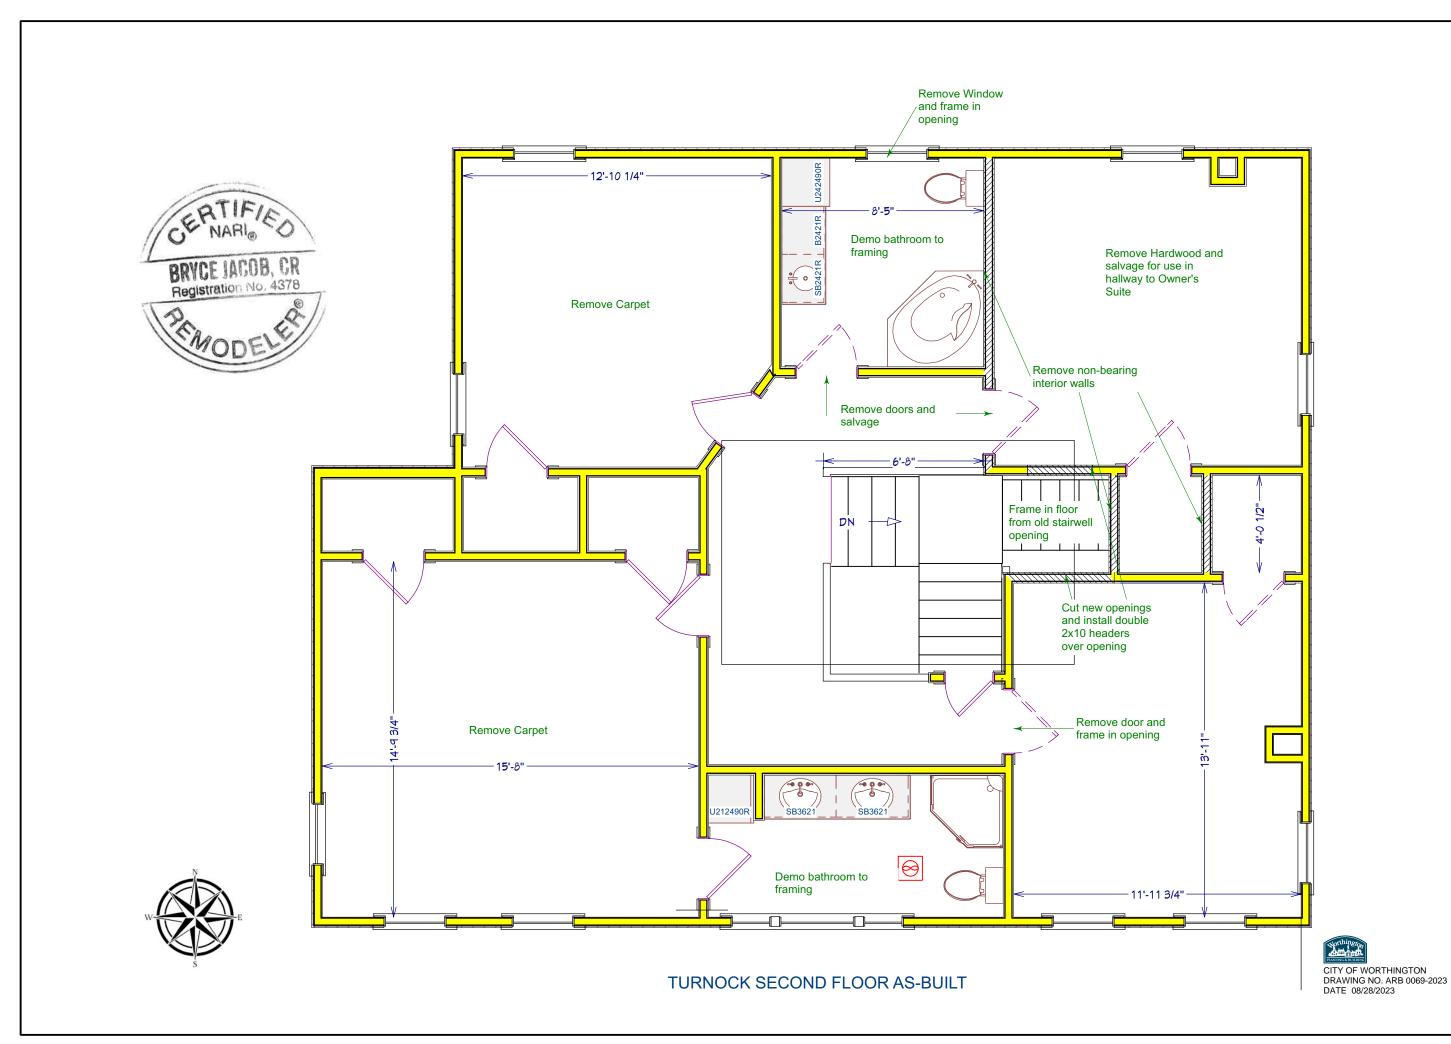

LEME ME

Kolby and Erin Turnock 100 W. Dublin-Granville Rd. Worth, Ohio 43085


Date: 8-21-23

Revisions:

Approval:

Page:

3

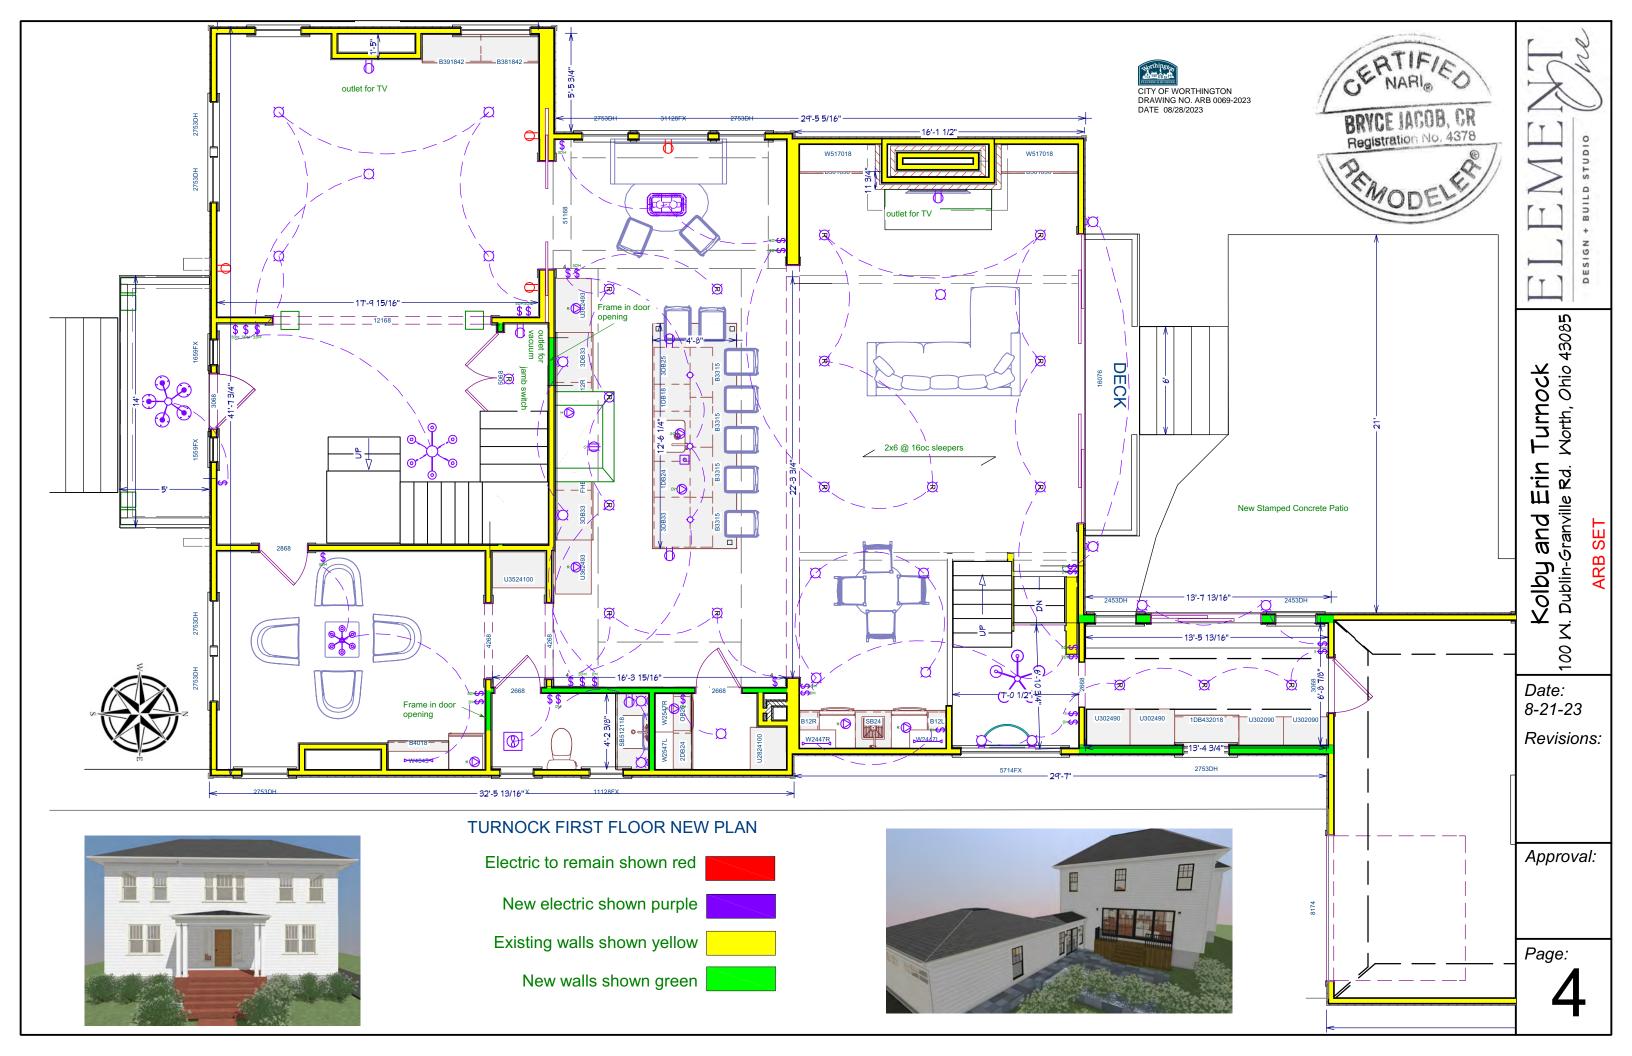

Approval:

Page:





ELECTRICAL SCHEDULE							
				DESCRIPTION			
E01	3	1	1 1/4 "	TUBE			
E02	2	1	10 1/16 "	TRADITIONAL SEMI FLUSH			
E03	4	1	11 "	MAIN STREET WALL SCONCE			
E04	2	1	11 13/16 "	CLORIS WALL SCONCE			
E05	2	1	12 "	GLOBE SCONCE			
E06	1	1	120 "	CANDELABRA CHANDELIER			
E07	1	1	24 "	VINTAGE CHANDELIER			
E08	1	1	28 1/8 "	SHADED CANDELABRA			
E09	1	1	3 5/8 "	FLUSH MOUNTED			
E10	1	1	3/4 "	EXHAUST			
E11	3	1	30 "	CONE PENDANT			
E12	1	1	30 1/8 "	SEASIDE CHANDELIER			
E13	1	1	42 11/16 "	RECTANGULAR SHELL CHANDELIER 3			
E14	15	1	5"	3-WAY DIMMER			
E15	2	1	5 "	3-WAY SWITCH			
E16	10	1	5"	DUPLEX			
E17	3	1	5"	FOUR WAY			
E18	3	1	5"	SINGLE POLE			
E19	9	1	5"	SINGLE POLE DIMMER			
E20	8	1	5 1/2 "	COMMON FLUSH MOUNT			
E21	1	1	5/16 "	DISHWASHER			
E22	1	1	5/16 "	GARBAGE DISPOSAL			
E23	1	1	5/16 "	HOOD W/ YENT			
E24	1	1	5/16 "	MICROWAVE			
E25	1	1	5/16 "	OVEN			
E26	17	1	5/16 "	RECESSED DOWN LIGHT 6			
E27	5	1	5/16 "	REFRIGERATOR			
E28	1	1	7/16 "	AIR SWITCH - COUNTERTOP			
E29	2	1	97/8"	FRANC SCONCE			
E30	4	2	16 5/8 "	BLADE CEILING FAN			
E31	3	2	3/4 "	EXHAUST			
E32	2	2	4 "	VANITY LIGHT			
E33	15	2	5"	DUPLEX			
E34	25	2	5"	SINGLE POLE			
E35	2	2	5"	SINGLE POLE DIMMER			
E36	2	2	5"	THREE WAY			
E37	1	2	5/16 "	CLOTHES DRYER			
E38	1	2	5/16 "	CLOTHES WASHER			
E39	25	2	5/16 "	RECESSED DOWN LIGHT 6			
E40	3	2	6 1/2 "	CONTEMPORARY FLUSH			
E41	3	2	7 1/2 "	SCONCE 1			
	1	2	80 "	CANDELABRA CHANDELIER			
E42		4	<i>0</i> 0 "	CANDELADRA CHANDELIER			





New electric shown purple	
Existing walls shown yellow	
New walls shown green	

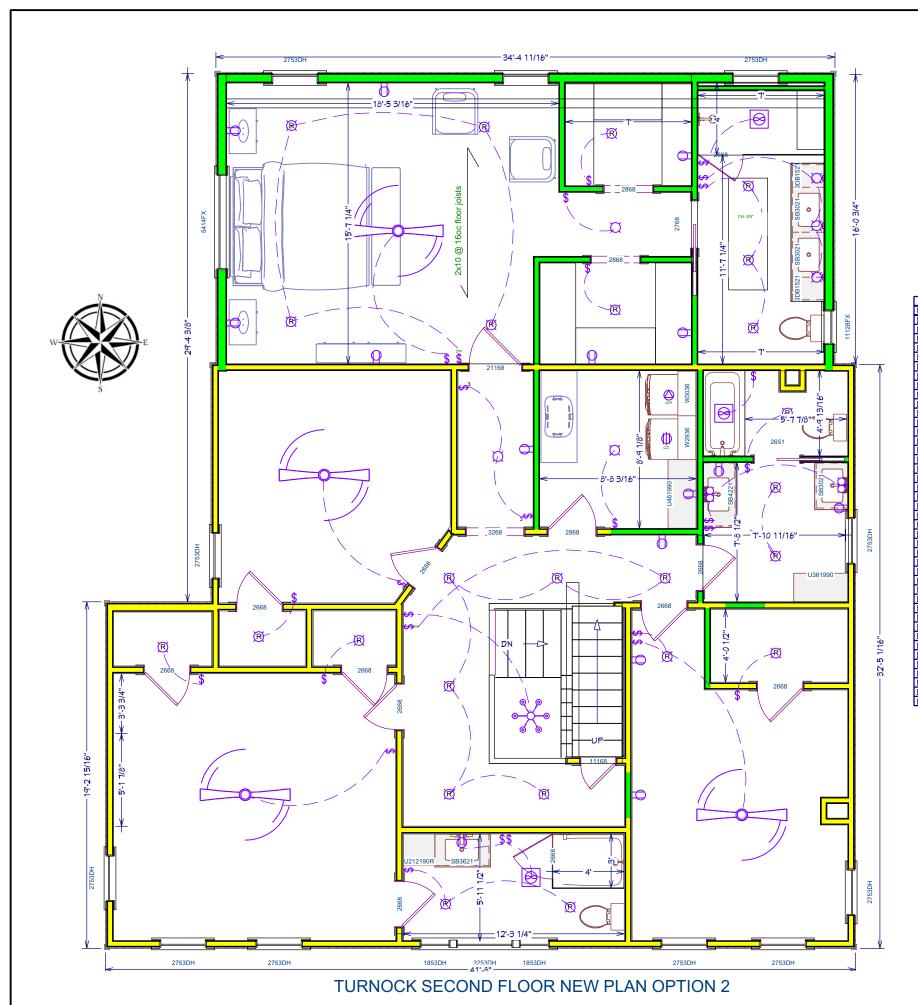

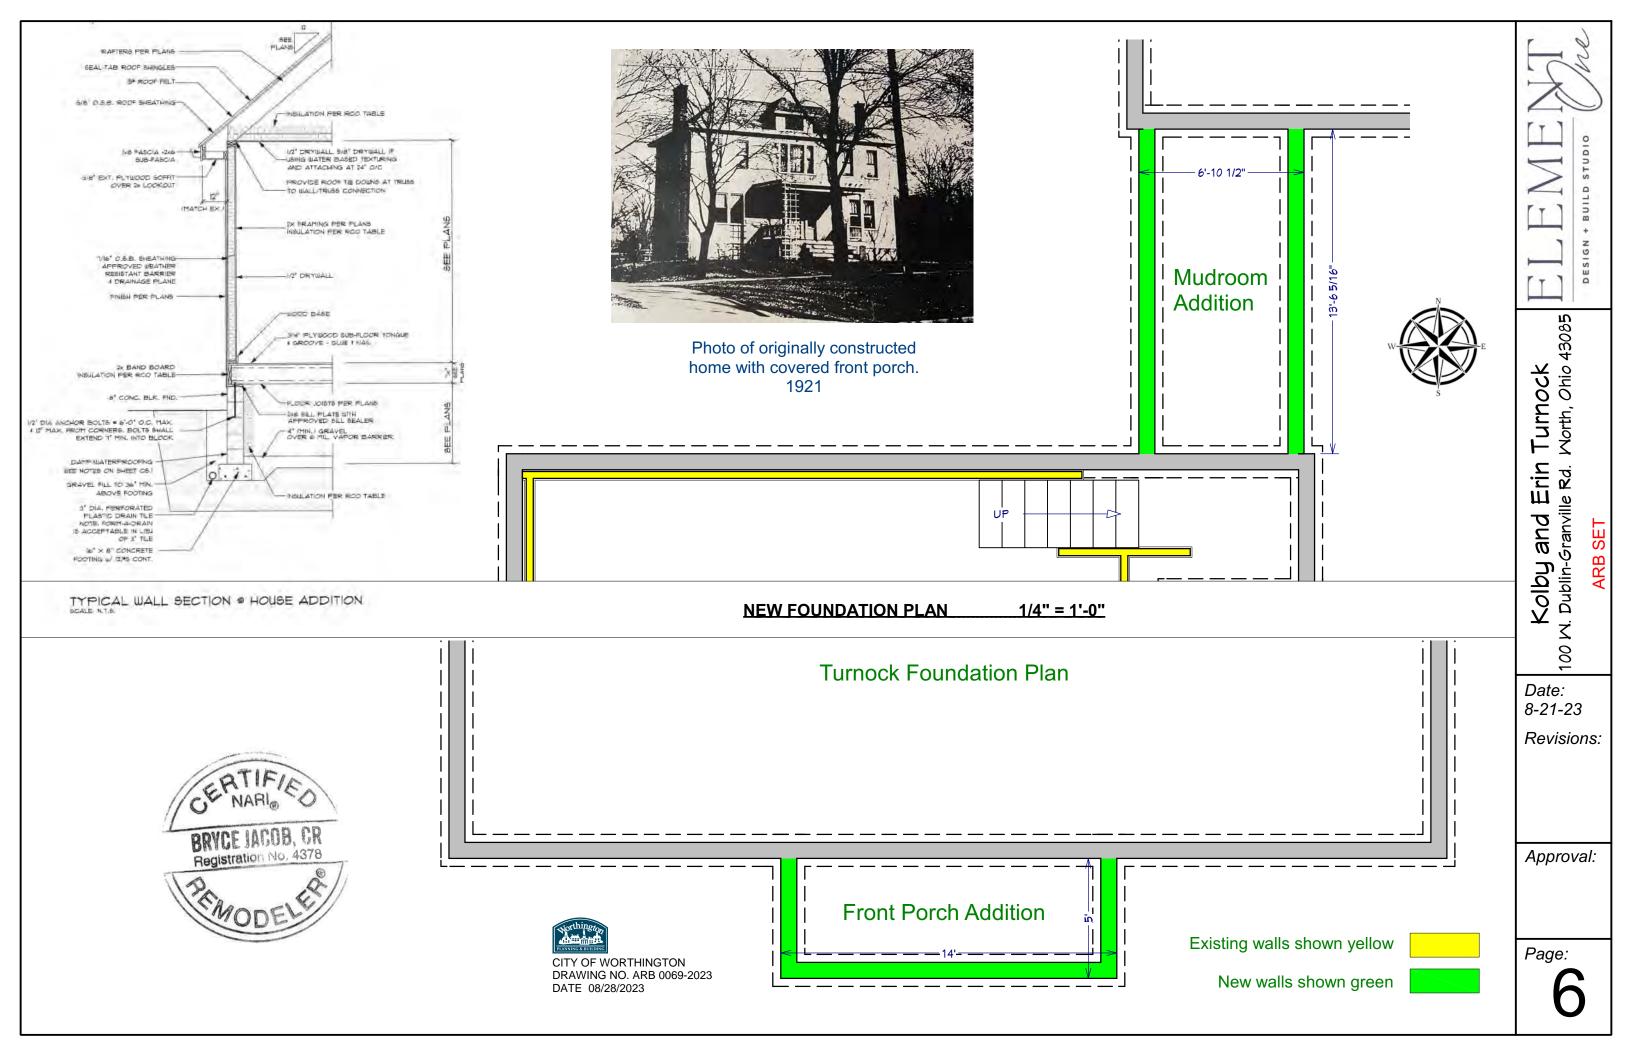



Turnock Worth, Ohio 43085 Εrin

**8** Kolby and E ARB SET

Date: 8-21-23

Revisions:

Approval:

Page:



**PERSPECTIVE** No Scale



**PERSPECTIVE** No Scale





CITY OF WORTHINGTON DRAWING NO. ARB 0069-2023 DATE 08/28/2023





Fiberglass Front Porch Posts (4)

Porch surface and








Trimline Double-Hung Windows and doors Black on rear of home only

**Stamped Concrete Patio** Pattern

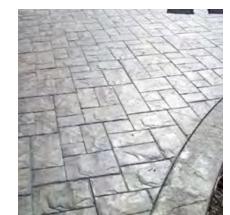



1/8" = 1'-0"

**NORTH ELEVATION** 

**SOUTH ELEVATION** 

BRYCE JACOB, CR Registration No. 4378

<u> 1/8" = 1'-0"</u>









Standing Seam on Porch Classic Bronze







Er: 100 M. Dublin-Granville Kolby and

Date: 8-21-23 Revisions:

Approval:

Page:

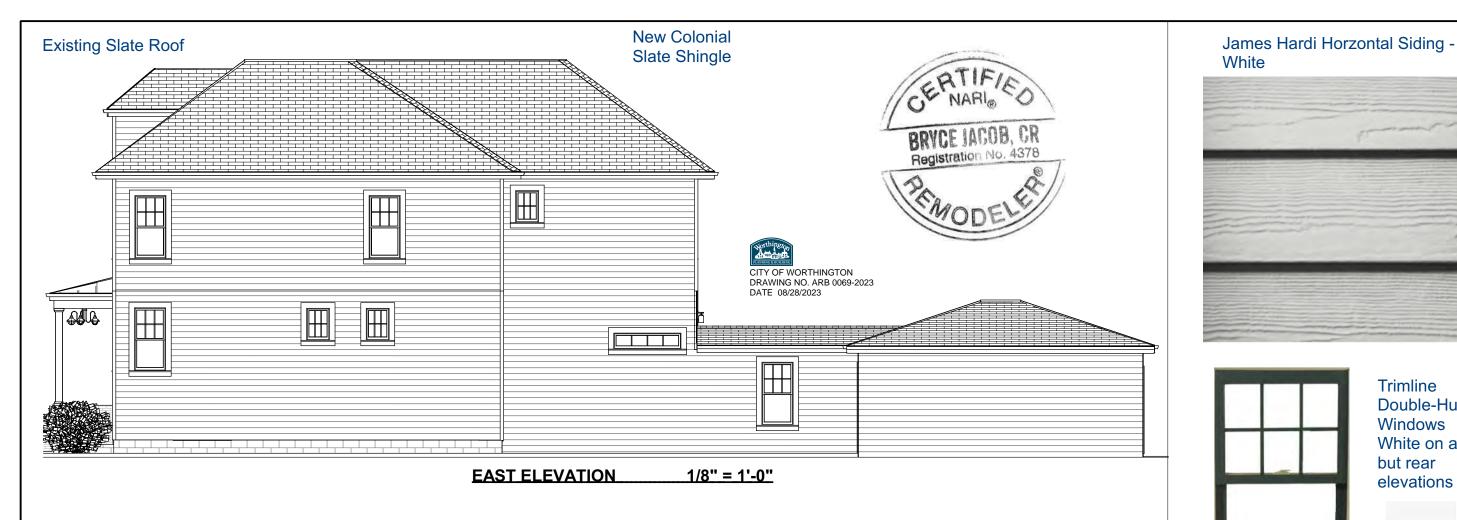

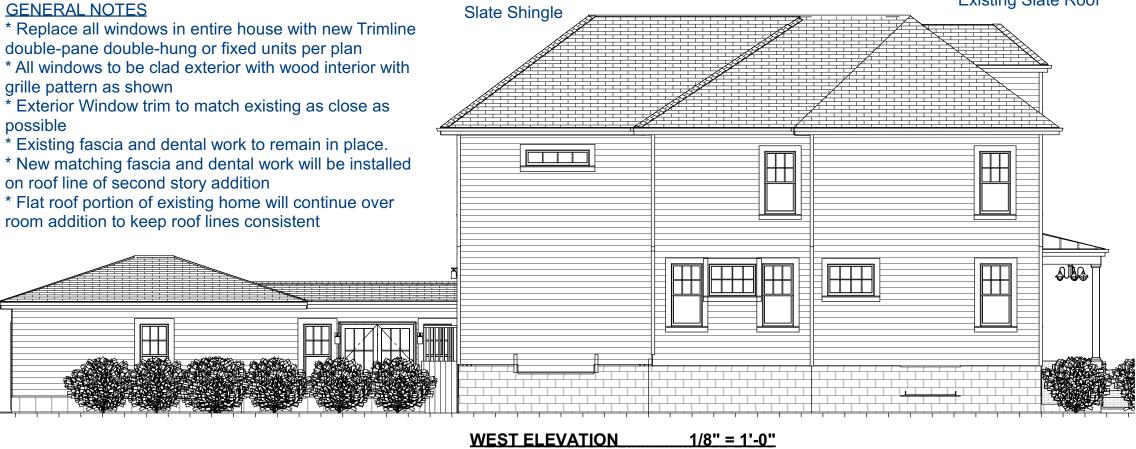





# **ARB APPLICATION** ARB 0071-2023 111 W. North St.

Plan Type: Architectural Review Board Project:

App Date:

08/29/2023

Work Class: Certificate of Appropriateness In Review

\$36,107.00

District:

City of Worthington

Exp Date:

Completed:

Approval

**Description:** Window replacement

**Expire Date:** 

Parcel: 100-000169

Address: 111 W North St Worthington, OH 43085 Main

Zone: R-10(Low Density Residence)

Applicant

Status:

Valuation:

Owner

Destany Todd 5850 Sawmill Road Dublin, OH 43017 Business: (614) 602-8100 Margaret Baum 111 W NORTH ST

Main

Worthington, OH 43085 Home: (970) 819-9725

Invoice No. INV-00004484	Fee Architectural Review Board		Fee Amount \$37.00	Amount Paid \$37.00
		Total for Invoice INV-00004484	\$37.00	\$37.00
		Grand Total for Plan	\$37.00	\$37.00

# 111 W. North St.







### dba: RENEWAL BY ANDERSEN OF COLUMBUS OHIO

Legal Name: Southard Corporation | License # (null) 1222 10th Street | Great Bend, Ks 67530 Phone: 6207935434 | Fax: 6207923221 | Columbusmeasures@southardcorp.com

Measure Tech: Nate Sattler,

**Margaret Baum** 

111 W North St Worthington, OH 43085 C: (970)819-9725

JOB

**101** Living

39-1/2" 65-3/8"

Window: , Double-Hung, Cottage 2:3, Slope Sill Insert, Exterior White, Interior White Glass: , All Sash: High Performance SmartSun Glass, No Pattern Hardware: , White, Standard Color Extra Lock Screen: , TruScene, Full Screen Grille Style: , Interior Wood Only (INTW) Grille Pattern: , Sash 1: Colonial 4w x 2h, Sash 2: Colonial 4w x 3h Misc: , Wrap 101-125 UI, Metal or Vinyl Cut Outs Construction: , Wrap Casing and Glue Unit (100 UI to 149 UI) (1), Remove Storm Windows (1) Material: , Adhesive Glue (0.2), White 0737107A02 (0.15), Butyl Flashing (7") (0.33), Hilti Foam (0.2), Novabond White (0.75), Screws , , 9036701 (0.01), Shims , , 7500653 (0.01) Sill Angle: , 10°

**102** Living

30-1/2" 53-3/8"

Window: , Double-Hung, 1:1, Slope Sill Insert, Traditional Checkrail, Exterior White, Interior White Glass: , All Sash: High Performance SmartSun Glass, No Pattern Hardware: , White Screen: , TruScene, Full Screen Grille Style: , Interior Wood Only (INTW) Grille Pattern: , All Sash: Colonial 3w x 2h Misc: , Wrap 100 UI and Under, Metal or Vinyl Cut Outs Construction: , Wrap Casing and Glue Unit (100 UI and Under) (1), Remove Storm Windows (1) Material: , Adhesive Glue (0.2), White 0737107A02 (0.15), Butyl Flashing (7") (0.33), Hilti Foam (0.2), Novabond White (0.75), Screws , , 9036701 (0.01), Shims , , 7500653 (0.01) Sill Angle: , 10°

**103** Living

30-1/2" 53-3/8"

Window: , Double-Hung, 1:1, Slope Sill Insert, Traditional Checkrail, Exterior White, Interior White Glass: , All Sash: High Performance SmartSun Glass, No Pattern Hardware: , White Screen: , TruScene, Full Screen Grille Style: , Interior Wood Only (INTW) Grille Pattern: , All Sash: Colonial 3w x 2h Misc: , Wrap 100 UI and Under,





39-1/2" 65-3/8"

# dba: RENEWAL BY ANDERSEN OF COLUMBUS OHIO

Legal Name: Southard Corporation I License # (null) 1222 10th Street I Great Bend, Ks 67530 Phone: 6207935434 | Fax: 6207923221 | Columbusmeasures@southardcorp.com

Measure Tech: Nate Sattler,

**Margaret Baum** 

111 W North St Worthington , OH 43085 C: (970)819-9725

				Metal or Vinyl Cut Outs <b>Construction:</b> , Wrap Casing and Glue Unit (100 UI and Under) (1), Remove Storm Windows (1) <b>Material:</b> , Adhesive Glue (0.2), White 0737107A02 (0.15), Butyl Flashing (7") (0.33), Hilti Foam (0.2), Novabond White (0.75), Screws, 9036701 (0.01), Shims, 7500653 (0.01) <b>Sill Angle:</b> , 10°
104	Bath	18"	31-3/4"	Window: , Awning, Base Frame, Exterior White, Interior White Glass: , All Sash: High Performance SmartSun Glass, No Pattern Hardware: , White Screen: , TruScene, Full Screen Grille Style: , Interior Wood Only (INTW) Grille Pattern: , All Sash: Colonial 2w x 3h Misc: , Wrap 100 UI and Under Construction: , Wrap Casing and Glue Unit (100 UI and Under) (1) Material: , Adhesive Glue (0.2), White 0737107A02 (0.15), Butyl Flashing (7") (0.33), Hilti Foam (0.2), Novabond White (0.75), Screws , , 9036701 (0.01), Shims , , 7500653 (0.01), RbA Trim Colonial White 7501863-001 (2)
105	Dining	39-1/2"	53-3/8"	Window: , Double-Hung, 1:1, Slope Sill Insert, Traditional Checkrail, Exterior White, Interior White Glass: , All Sash: High Performance SmartSun Glass, No Pattern Hardware: , White, Standard Color Extra Lock Screen: , TruScene, Full Screen Grille Style: , Interior Wood Only (INTW) Grille Pattern: , All Sash: Colonial 4w x 2h Misc: , Wrap 100 UI and Under, Metal or Vinyl Cut Outs Construction: , Wrap Casing and Glue Unit (100 UI and Under) (1), Remove Storm Windows (1) Material: , Adhesive Glue (0.2), White 0737107A02 (0.15), Butyl Flashing (7") (0.33), Hilti Foam (0.2), Novabond White (0.75), Screws , , 9036701 (0.01), Shims , , 7500653 (0.01) Sill Angle: , 10°
106	Dining			Window: , Double-Hung, Cottage 2:3, Slope Sill Insert, Exterior White,

Interior White Glass: , All





### dba: RENEWAL BY ANDERSEN OF COLUMBUS OHIO

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**Margaret Baum** 

111 W North St Worthington, OH 43085 C: (970)819-9725

Sash: High Performance SmartSun Glass, No Pattern **Hardware:**, White, Standard Color Extra Lock **Screen:**, TruScene, Full Screen **Grille Style:**, Interior Wood Only (INTW) **Grille Pattern:**, Sash 1: Colonial 4w x 2h, Sash 2: Colonial 4w x 3h **Misc:**, Wrap 101-125 UI, Metal or Vinyl Cut Outs **Construction:**, Wrap Casing and Glue Unit (100 UI to 149 UI) (1), Remove Storm Windows (1) **Material:**, Adhesive Glue (0.2), White 0737107A02 (0.15), Butyl Flashing (7") (0.33), Hilti Foam (0.2), Novabond White (0.75), Screws, 9036701 (0.01), Shims, 7500653 (0.01) **Sill Angle:**, 10°

**207** Primary Bedroom

35-3/8" 45-3/8"

Window: , Double-Hung, 1:1, Slope Sill Insert, Traditional Checkrail, Exterior White, Interior White Glass: , All Sash: High Performance SmartSun Glass, No Pattern Hardware: , White, Standard Color Extra Lock Screen: , TruScene, Full Screen Grille Style: , Interior Wood Only (INTW) Grille Pattern: , All Sash: Colonial 4w x 2h Misc: , Wrap 100 UI and Under, Metal or Vinyl Cut Outs Construction: , Wrap Casing and Glue Unit (100 UI and Under) (1), Remove Storm Windows (1) Material: , Adhesive Glue (0.2), White 0737107A02 (0.15), Butyl Flashing (7") (0.33), Hilti Foam (0.2), Novabond White (0.75), Screws , , 9036701 (0.01), Shims , , 7500653 (0.01) Sill Angle: , 10°

**208** Primary Bedroom

30-3/8" 45-3/8"

Window: , Double-Hung, 1:1, Slope Sill Insert, Traditional Checkrail, Exterior White, Interior White Glass: , All Sash: High Performance SmartSun Glass, No Pattern Hardware: , White Screen: , TruScene, Full Screen Grille Style: , Interior Wood Only (INTW) Grille Pattern: , All Sash: Colonial 3w x 2h Misc: , Wrap 100 UI and Under, Metal or Vinyl Cut Outs Construction: , Wrap Casing





### dba: RENEWAL BY ANDERSEN OF COLUMBUS OHIO

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Measure Tech: Nate Sattler,

Margaret Baum

111 W North St Worthington, OH 43085 C: (970)819-9725

and Glue Unit (100 UI and Under) (1), Remove Storm Windows (1) **Material:**, Adhesive Glue (0.2), White 0737107A02 (0.15), Butyl Flashing (7") (0.33), Hilti Foam (0.2), Novabond White (0.75), Screws , , 9036701 (0.01), Shims , , 7500653 (0.01) **Sill Angle:** , 10°

**209** Office

30-3/8" 45-3/8"

Window: , Double-Hung, 1:1, Slope Sill Insert, Traditional Checkrail, Exterior White, Interior White Glass: , All Sash: High Performance SmartSun Glass, No Pattern Hardware: , White Screen: , TruScene, Full Screen Grille Style: , Interior Wood Only (INTW) Grille Pattern: , All Sash: Colonial 3w x 2h Misc: , Wrap 100 UI and Under, Metal or Vinyl Cut Outs Construction: , Wrap Casing and Glue Unit (100 UI and Under) (1), Remove Storm Windows (1) Material: , Adhesive Glue (0.2), White 0737107A02 (0.15), Butyl Flashing (7") (0.33), Hilti Foam (0.2), Novabond White (0.75), Screws , , 9036701 (0.01), Shims , , 7500653 (0.01) Sill Angle: , 10°

**210** Office

30-3/8" 45-3/8"

Window: , Double-Hung, 1:1, Slope Sill Insert, Traditional Checkrail, Exterior White, Interior White Glass: , All Sash: High Performance SmartSun Glass, No Pattern Hardware: , White Screen: , TruScene, Full Screen Grille Style: , Interior Wood Only (INTW) Grille Pattern: , All Sash: Colonial 3w x 2h Misc: , Wrap 100 UI and Under, Metal or Vinyl Cut Outs Construction: , Wrap Casing and Glue Unit (100 UI and Under) (1), Remove Storm Windows (1) Material: , Adhesive Glue (0.2), White 0737107A02 (0.15), Butyl Flashing (7") (0.33), Hilti Foam (0.2), Novabond White (0.75), Screws , , 9036701 (0.01), Shims , , 7500653 (0.01) Sill Angle: , 10°

**211** Upstairs hall

30-3/8" 45-3/8"

**Window:**, Double-Hung, 1:1, Slope Sill Insert, Traditional Checkrail, Exterior White, Interior White **Glass:**, All Sash: High Performance SmartSun Glass,





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No Pattern **Hardware:**, White **Screen:**, TruScene, Full Screen **Grille Style:**, Interior Wood Only (INTW) **Grille Pattern:**, All Sash: Colonial 3w x 2h **Misc:**, Wrap 100 UI and Under, Metal or Vinyl Cut Outs **Construction:**, Wrap Casing and Glue Unit (100 UI and Under) (1), Remove Storm Windows (1) **Material:**, Adhesive Glue (0.2), White 0737107A02 (0.15), Butyl Flashing (7") (0.33), Hilti Foam (0.2), Novabond White (0.75), Screws, 9036701 (0.01), Shims, 7500653 (0.01) **Sill Angle:**, 10°

**212** Bath

30-3/8" 45-3/8"

Window: , Double-Hung, 1:1, Slope Sill Insert, Traditional Checkrail, Exterior White, Interior White Glass: , All Sash: High Performance SmartSun Glass, No Pattern Hardware: , White Screen: , TruScene, Full Screen Grille Style: , Interior Wood Only (INTW) Grille Pattern: , All Sash: Colonial 3w x 2h Misc: , Wrap 100 UI and Under, Metal or Vinyl Cut Outs Construction: , Wrap Casing and Glue Unit (100 UI and Under) (1), Remove Storm Windows (1) Material: , Adhesive Glue (0.2), White 0737107A02 (0.15), Butyl Flashing (7") (0.33), Hilti Foam (0.2), Novabond White (0.75), Screws , , 9036701 (0.01), Shims , , 7500653 (0.01) Sill Angle: , 10°

**213** Guest

39-3/8" 45-3/8"

Window: , Double-Hung, 1:1, Slope Sill Insert, Traditional Checkrail, Exterior White, Interior White Glass: , All Sash: High Performance SmartSun Glass, No Pattern Hardware: , White, Standard Color Extra Lock Screen: , TruScene, Full Screen Grille Style: , Interior Wood Only (INTW) Grille Pattern: , All Sash: Colonial 4w x 2h Misc: , Wrap 100 UI and Under, Metal or Vinyl Cut Outs Construction: , Wrap Casing and Glue Unit (100 UI and Under) (1), Remove Storm Windows (1) Material: , Adhesive Glue (0.2),





### dba: RENEWAL BY ANDERSEN OF COLUMBUS OHIO

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Measure Tech: Nate Sattler,

**Margaret Baum** 

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White 0737107A02 (0.15), Butyl Flashing (7") (0.33), Hilti Foam (0.2), Novabond White (0.75), Screws, , 9036701 (0.01), Shims, , 7500653 (0.01) **Sill Angle:** , 10°

**214** Guest

35-3/8" 45-3/8"

Window: , Double-Hung, 1:1, Slope Sill Insert, Traditional Checkrail, Exterior White, Interior White Glass: , All Sash: High Performance SmartSun Glass, No Pattern Hardware: , White, Standard Color Extra Lock Screen: , TruScene, Full Screen Grille Style: , Interior Wood Only (INTW) Grille Pattern: , All Sash: Colonial 4w x 2h Misc: , Wrap 100 UI and Under, Metal or Vinyl Cut Outs Construction: , Wrap Casing and Glue Unit (100 UI and Under) (1), Remove Storm Windows (1) Material: , Adhesive Glue (0.2), White 0737107A02 (0.15), Butyl Flashing (7") (0.33), Hilti Foam (0.2), Novabond White (0.75), Screws , , 9036701 (0.01), Shims , , 7500653 (0.01) Sill Angle: , 10°

PRODUCTS: 14 WINDOWS: 14 PATIO DOORS: 0 ENTRY DOORS: 0 SPECIALTY: 0 MISC: 0






# dba: RENEWAL BY ANDERSEN OF COLUMBUS OHIO


Legal Name: Southard Corporation | License # (null) 1222 10th Street | Great Bend, Ks 67530 Phone: 6207935434 | Fax: 6207923221 |

Columbusmeasures@southardcorp.com Measure Tech: Nate Sattler, **Margaret Baum** 

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**UNIT NOTES** 

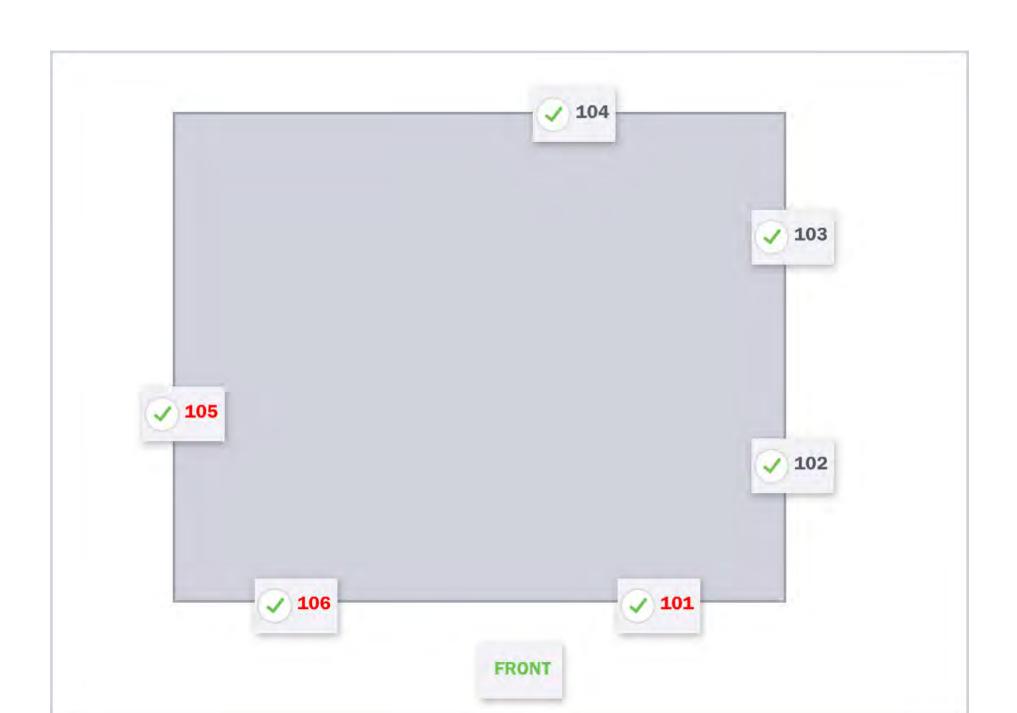

UNIT NOTES

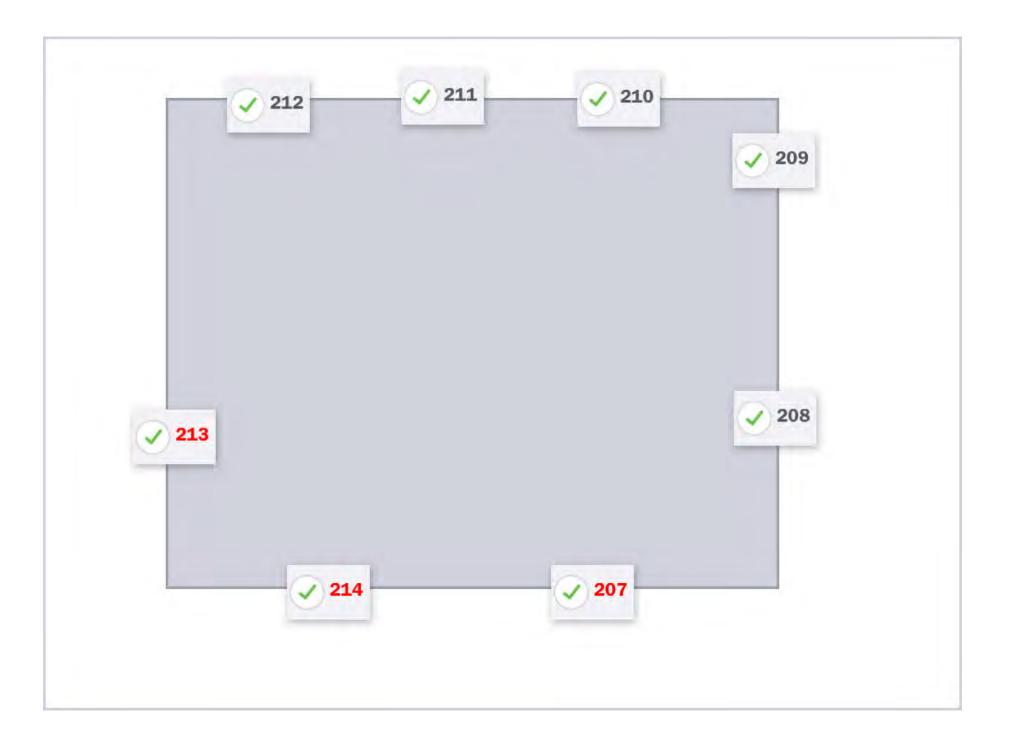



# Fibrex® Composite Material



Windows Manufactured
with Fibrex® Composite
Material – a Stronger Solution
with Long Lasting Beauty

#### Reinventing the Window

Innovation has been a hallmark of Andersen Corporation since its founding in 1903. From implementing "mass production" techniques in 1904 (nine years before Henry Ford), to producing the first completely assembled window unit in the industry (1926), to becoming the world's largest specialized window frame factory in 1929, our guiding principle has always been to "make a product that is different and better." Each step of the way we have incorporated the latest technologies, fine precision, and high standards in our quest to be better.

#### Introducing Fibrex® Material

One of our most innovative ideas is Fibrex material. This revolutionary composite combines the strength and stability of wood with the low-maintenance features of vinyl. In fact, you might say it's an evolutionary product. Andersen scientists developed the first hollow vinyl window in the U.S. in 1959, and engineered composite window materials in the 1960s and 1970s. In 1992, Andersen perfected composite window technology and patented Fibrex material. Today, Fibrex material is the perfect choice for your new replacement windows.

FIBREX®	MATERIAL	IS A BETTER	CHOICE
			Other Met

F	ibr	ex	M	a	te	ri	a	I

Strength

Insulation

Beauty

Warranty

Because Fibrex® composite material is strong, we can make our sash and frames narrower. Narrower frames mean more glass and more view.

Fibrex composite material has superior thermal insulating properties. Combined with Andersen® High-Performance Low-E4® glass, this helps your home stay warmer in winter and cooler in summer. You can help save money on your energy bills. Your home feels more comfortable.

**Low** Fibrex composite material never needs scraping or painting. **Maintenance** It won't rot, decay, or mold.<sup>1</sup>

Renewal by Andersen® replacement windows preserve the architectural beauty of your home. Frame and sash design reflect the shape and lines of your original windows.

The unique extruded Fibrex composite material can be made into any kind of window – including curved specialty windows.

Environmental Responsibility

40% of the raw material by weight used to make Fibrex composite material is clean, reclaimed wood fiber. Reclaimed materials in the manufacturing process can also be reground and reused.

A window is not just glass and some framing material. It's a precise combination of glass, frame, and quality installation. We back it all with a Products and Installation Limited Warranty<sup>1</sup> that is one of the best in the business.

#### **Other Materials**

Vinyl frames are known to have a higher expansion/contraction rate and can bow, breaking the glass seal.

Aluminum window frames conduct heat and cold. Heat leaks out of your house in the winter and into your house in the summer.

Fiberglass frames are painted and may need regular maintenance.

Most replacement windows have square profiles that may look artificial in your home. Vinyl frame material is often thicker, reducing glass area.

Fiberglass can only be made into straight lineals.

Fiberglass is a thermoset material and cannot be reformed into new profiles.

Installation is rarely covered in the written warranty.

CITY OF WORTHINGTON DRAWING NO. ARB 0071-2023 DATE 08/29/2023

<sup>1</sup> See Renewal by Andersen Products and Installation Transferable Limited Warranty for details.

### Fibrex® Composite Material - a Smarter Material with Unmatched Performance

Andersen Corporation was founded in 1903 and soon revolutionized the way windows

VEARS
or
Innovation
AND
Excellence

were installed by pre-cutting materials for carpenters to assemble on the building site. Over the years, Andersen has introduced many industry firsts. Andersen continues to be a leader in producing products that last longer, look better, and function smoothly for many years.

Over the years, Andersen has proudly introduced industry milestones, including new technologies and methods that made windows and doors last longer, look better, and function

as intended for many years. By the 1950s, Andersen's research and development efforts were laying the groundwork for Fibrex® composite material and a brand new way to provide homeowners with beautiful, high quality, and efficient replacement windows.



#### 1959

Andersen is the first company to develop a hollow vinyl window in the U.S. but decides it doesn't have enough structural integrity. But the low maintenance feature of the vinyl had possibilities.

#### 1968-1978

Andersen expands its use of reclaimed wood fibers into pressed wood boards for hidden components of the window. Engineered wood – wood pieces combined and pressed together – prove stronger than traditional raw wood.

#### 1991

Fibrex® composite material is patented. It combines the best qualities of wood and thermoplastic polymers.

#### 1995

Renewal by Andersen is founded. Now one of the largest window replacement companies in the U.S., Renewal by Andersen windows incorporate more than 40 percent reclaimed wood fiber by weight from other window manufacturing operations.











#### 1966

Andersen creates the "cladwood" window and door category. Andersen Research & Development invents a way to weld the corners together for airtight and watertight performance.

#### 1970s

Andersen strives to improve the return on its resources by making windows and doors that perform and last. Andersen sees the extra wood created by its manufacturing process as a potential material resource. The company develops a window sash made from reclaimed wood fibers and thermoplastic polymers that performs and weathers well. But manufacturing methods are inefficient until developments are made in the next decade.

#### 1993

Fibrex composite material used as a sub-sill component in the Andersen® Frenchwood® hinged patio door.
The Fibrex composite material sill is selected for its superior strength and resistance to rot and decay, and performs exceptionally well in this demanding role.

#### 2008

Renewal by Andersen® windows achieves the highest SCS certified recycled content of any window replacement company.



CITY OF WORTHINGTON DRAWING NO. ARB 0071-2023 DATE 08/29/2023

All of our windows are made of Fibrex composite material, a revolutionary composite made from reclaimed wood fiber blended with a polymer. This gives our windows the strength and durability of wood and the low-maintenance features of vinyl, while greatly limiting thermal transmittance that can be found in other window materials such as metal.

Unlike many other window materials, Fibrex composite material won't flake, rust, blister, peel, crack, pit, corrode, or rot.<sup>2</sup> It is also two times stronger than vinyl and resists warping and bowing. Never worry about scraping or painting your windows again.



To this day, Andersen Corporation operates under the core principles founder Hans Andersen put in place

over a century ago.



When you purchase Renewal by Andersen® windows, you are purchasing time-tested innovation – and a piece of history that will last for years to come?





# Over 117 Years of Innovation and Excellence

Andersen® products and patents have revolutionized the window and door industry for over 117 years, changing the home construction industry, how homes are designed, and even how we live in our homes.

We are constantly testing and introducing new materials. Heat and cold chambers mimic extreme temperature conditions. Simulating devices produce extremes of dry and wet to test all new products. Windows, hardware, finishes, and packaging materials all undergo testing.

"You can get environmentally responsible replacement windows that are beautiful and help provide energy savings. We're proud that our windows have earned SCS Global Services recycled content and indoor air quality certifications, demonstrating our commitment to sustainability."

Troy Barrow
 President, Renewal by Andersen




CITY OF WORTHINGTON DRAWING NO. ARB 0071-2023 DATE 08/29/2023

The Better Way to a Better Window®

### The "Material" Difference


Consider all you expect windows to do for your home. Fibrex® composite material makes a difference in every instance. Measured across a range of conditions that affect the efficiency, maintenance, and beauty of windows, Fibrex composite material performs well compared to vinyl, aluminum, fiberglass, and wood. Take a look and we think you'll agree – replacement windows made of Fibrex composite material are the right choice for your home.

#### **Durable and Reliable**

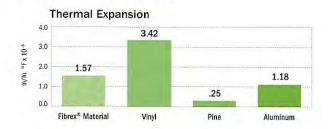

Fibrex composite material is durable and reliable, and – like wood, fiberglass, and aluminum – it expands and contracts very little. However, vinyl can expand and contract significantly. Vinyl may cause cracks, bowing, and air or water leaks. Windows made of Fibrex composite material will perform better in winter and summer than windows made of vinyl.

#### An Excellent Insulator

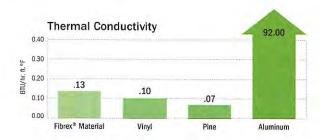


Fibrex composite material has excellent insulating properties on par with wood, vinyl, or fiberglass. Aluminum, on the other hand, transfers heat out of your home and allows outdoor temperatures to chill window areas inside. Fibrex composite material insulates about 700 times better than aluminum.

### The Process Is Easy


Visit renewalbyandersen.com or call your local Renewal by Andersen showroom for a free in-home or no-contact consultation.

#### Stable and Predictable

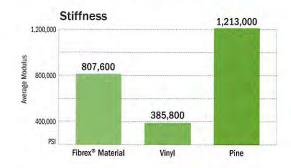

Fibrex composite material is twice as stable and rigid as vinyl. Wood's average stiffness is higher, but it's less predictable than Fibrex composite material because of wood's natural variations like grain, knots, and moisture content. Fibrex composite material is strong so frames can be made narrower than with other framing materials. Narrower frames mean more glass, and more view. Fibrex composite material can be made into any style of window – including curved specialty windows – and in colors to complement every home.

#### **Decay Resistant**

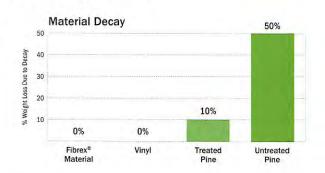

With Fibrex composite material, a special polymer formulation surrounds and coats each wood fiber in the manufacturing process, providing exceptional resistance to rot and fungal growth. Renewal by Andersen's windows, made with Fibrex composite material, never need scraping or painting because they are warranted not to flake, rust, blister, peel, crack, pit, or corrode.





The Better Way to a Better Window\*



# ARB APPLICATION ARB 0072-2023 53 W. Wilson Bridge Rd.

Architectural Review Board Plan Type:

In Review

Project:

App Date:

08/29/2023

Valuation:

Work Class: Certificate of Appropriateness

City of Worthington District:

Exp Date:

Completed:

Status: \$850,000.00

**Approval** 

Description: Tenant build-out of a new Huey Magoo's restaurant with an exterior patio

**Expire Date:** 

100-006791 Parcel:

Address: 53 W Wilson Bridge Rd Worthington, OH 43085 Main

Zone:

Owner Ronda Hobart Applicant Jill Grosnoff

Main

Business: (614) 582-9635

220 East Central Parkway

Altamonte Springs, FL 32701 Business: (407) 645-5008

Invoice No. **Fee Amount Amount Paid** INV-00004488 \$200.00 Architectural Review Board \$200.00 \$200.00 \$200.00 Total for Invoice INV-00004488 \$200.00 \$200.00 **Grand Total for Plan** 

# 53 W. Wilson Bridge Rd.







10

EXISTING EXTERIOR ELEVATION 1/4" = 1'-0"

INTERPLAN LL

ARCHITECTURE ENGINEERING PERMITTING

220 E. CENTRAL PKWY, STE 4000 ALTAMONTE SPRINGS, FL 32701 407.645.5008

THIS DOCUMENT IS NOT FOR REGULATORY APPROVAL, PERMITTING, OR CONSTRUCTION.

License #:\_

no date remarks

HUEY MAGOO'S

WORTHINGTON

WORTHINGTON GATEWAY 53 W. WILSON BRIDGE ROAD WORTHINGTON, OH 43085


PROJECT NO: 2022.0800 DATE: 08/09/23

CITY OF WORTHINGTON DRAWING NO. ARB 0072-2023 DATE 08/29/2023

EXTERIOR ELEVATIONS

CHECKED: JMA DRAWN: BW

JENARS - 08/10/2023 10:23:59 AM

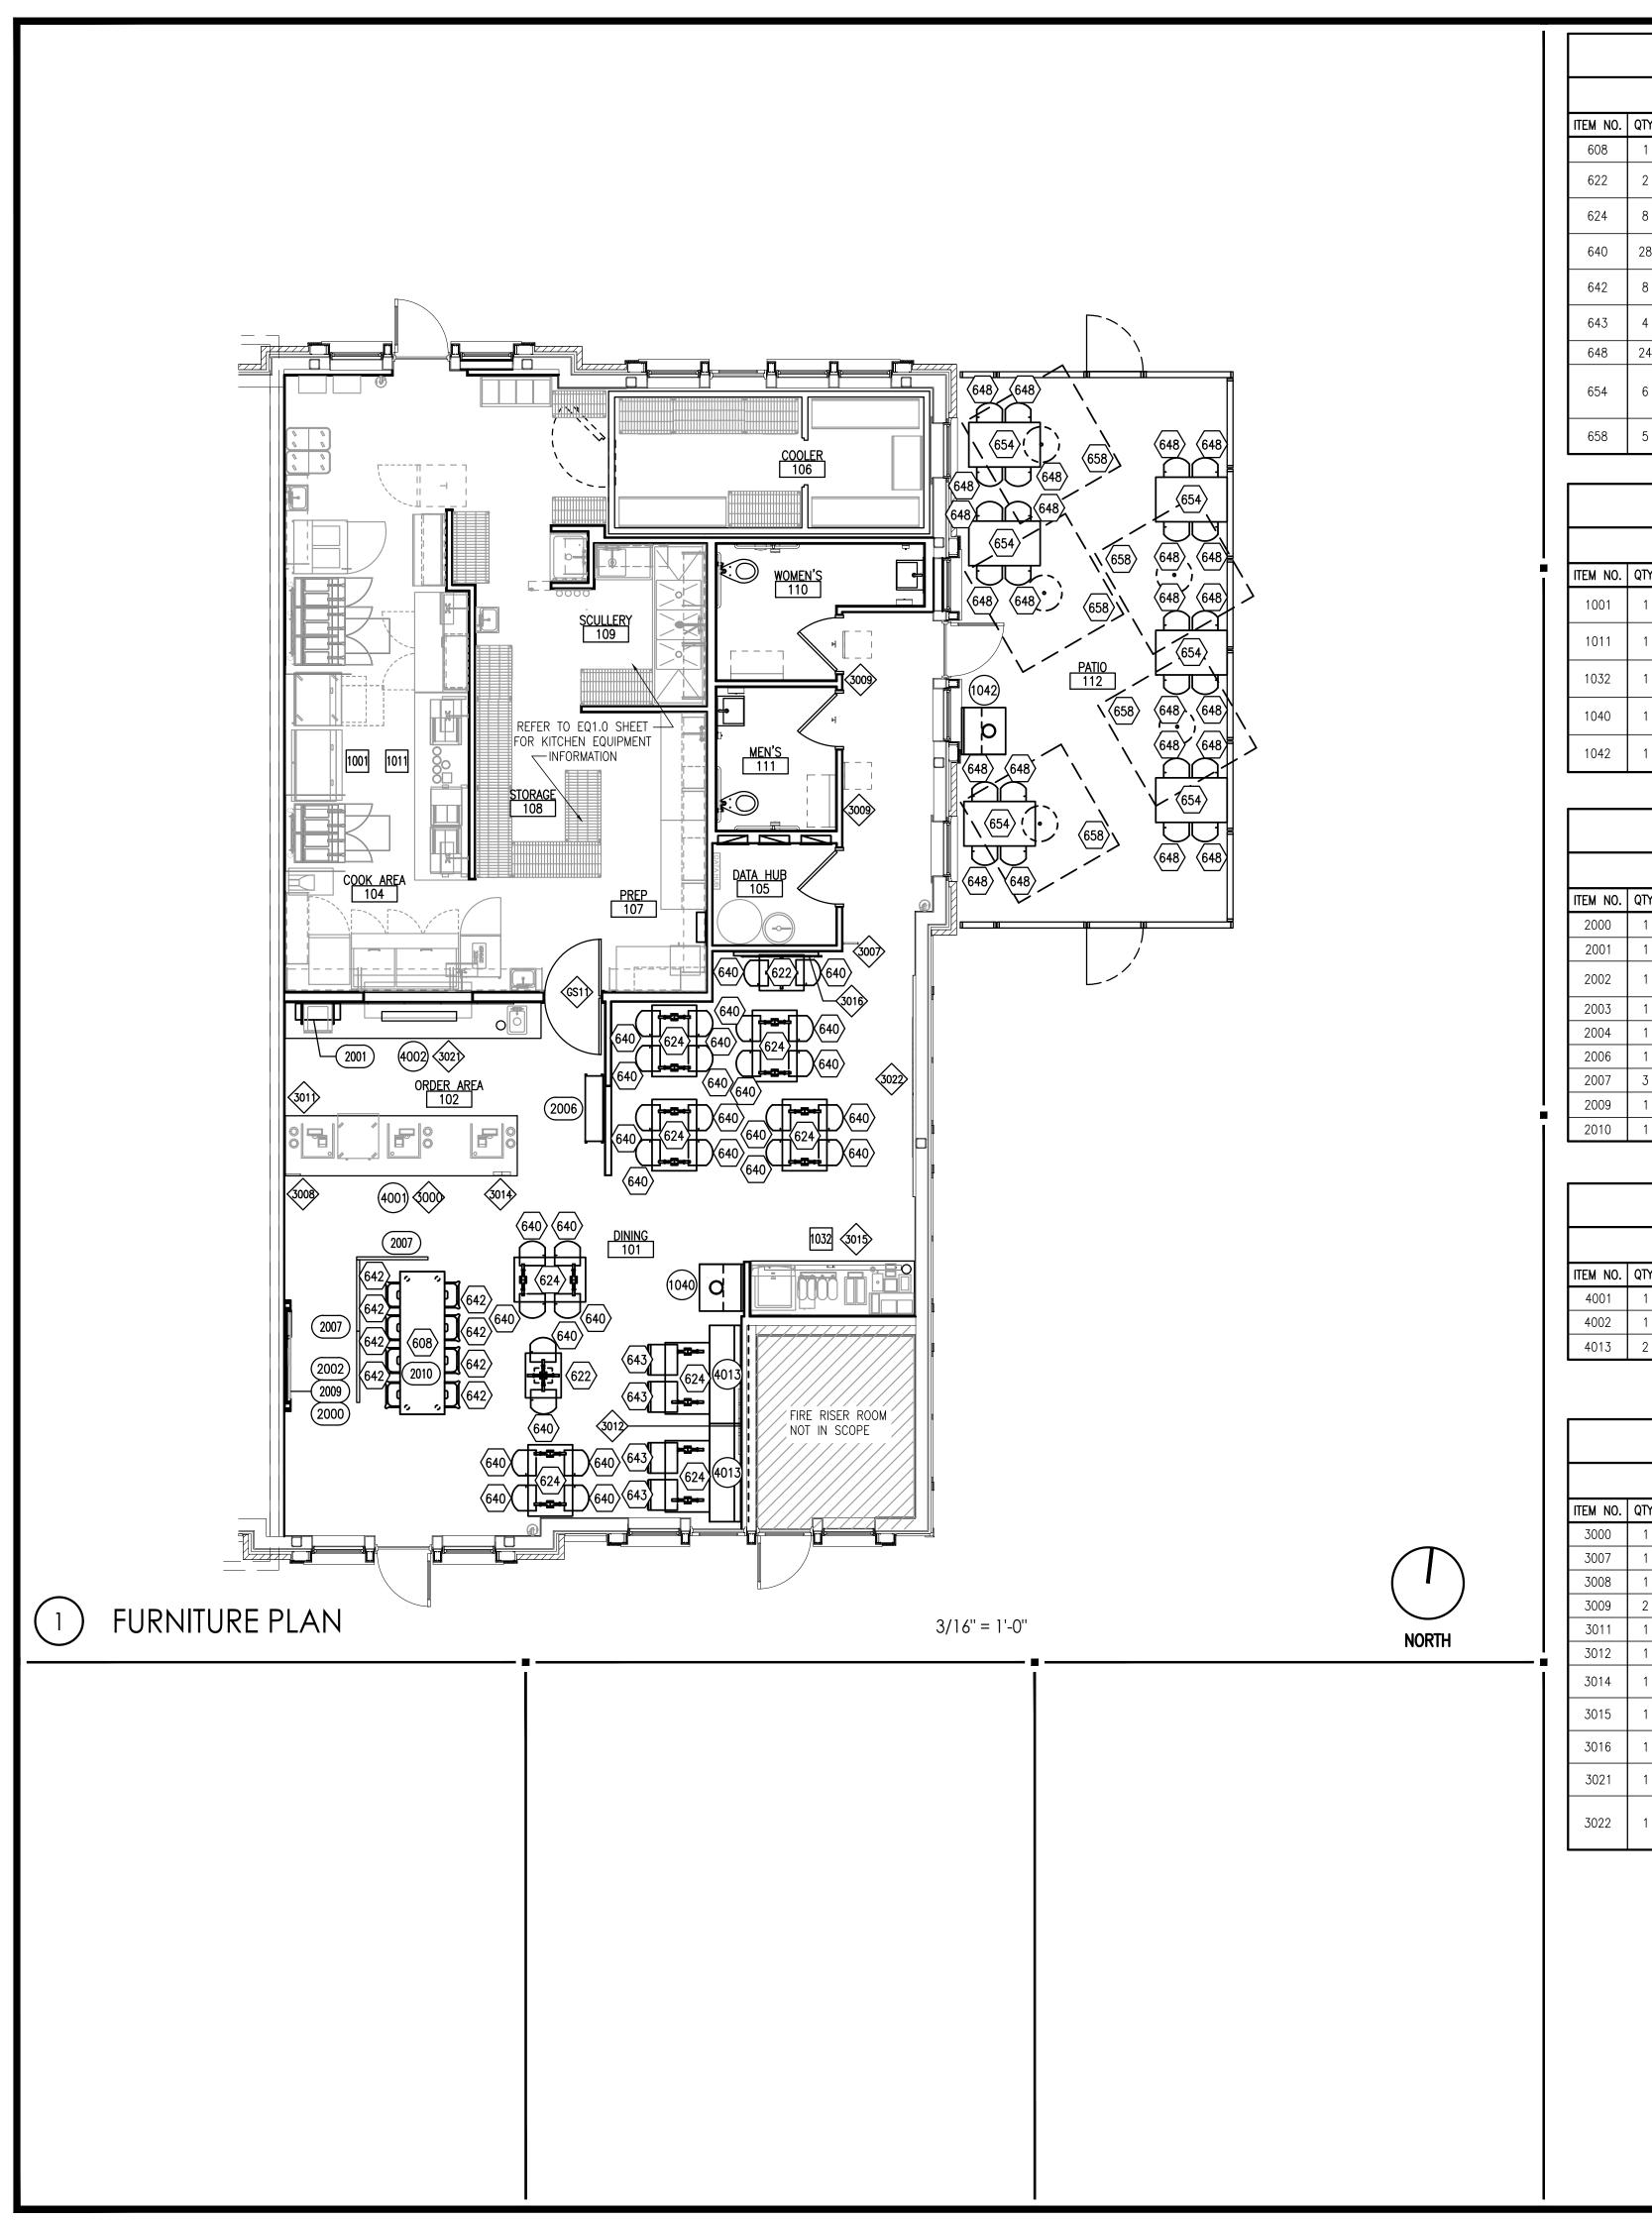

	FURNITURE SCHEDULE 🔷										
	SEE FINISH SCHEDULE ON A6.1 FOR FULL SPECIFICATIONS. ALL QUANTITIES, MANUFACTURER, AND MODEL NO. TO BE VERIFIED WITH OWNER PRIOR TO ORDERING.										
ITEM NO.	QTY.	FURNITURE DESCRIPTION	MANUFACTURER	MODEL NO.	REMARKS						
608	1	8'-0" X 2'-6" COMMUNITY TABLE W/ WOOD TOP AND ELECTRICAL CHASE (CONNECTION BY ELECTRICIAN)	BENCHMARK		LOCATION INDOOR						
622	2	24 X 30 WOOD TABLE W/ TWO WRINKLE BLACK BASES (STANDARD HEIGHT 1.75" THICKNESS)	BENCHMARK		LOCATION INDOOR TT-1A						
624	8	30 X 48 WOOD TABLE W/ 2 ADA WRINKLE BLACK BASES (STANDARD HEIGHT 1.75" THICKNESS)	BENCHMARK		LOCATION INDOOR TT-2A						
640	28	DINING ROOM CHAIR — SILVER POWDER COAT FINISH	MSW	14972	LOCATION INDOOR CH-1						
642	8	BAR STOOL BACKLESS – RED POWDER COAT FINISH (30" SEAT HEIGHT)	MSW	14605	LOCATION INDOOR BS-2						
643	4	DINING ROOM CHAIR — NATURAL WITH BLACK FRAME	MSW	JULIE STYLE	LOCATION INDOOR CH-2						
648	24	PATIO CHAIR — RED POWDER COAT FINISH	EMU	DARWIN 522	LOCATION OUTDOOR						
654	6	WES TABLE TOP, 48" X 32" X 1-1/2"H, RECTANGLE, OUTDOOR, UV, HEAT AND STAIN RESISTANT, MOLDED LAMINATE; FINISH 272 KANSAS	EMU	W4832	LOCATION OUTDOOR INCLUDE BASE A1361 (QTY 2) ZAK TABLE BASE, DINING HEIGHT						
658	5	PATIO UMBRELLA BAY MASTER FIBERFLEX CLASSIC PARASOL 6.5' SQUARE	TUUCI	BMFF6.5SQ	LOCATION OUTDOOR INCLUDE 90LB BASE						

		CUSTOM STAINLESS			
		SEE FINISH SCHEDULE ON A6.1 FOR FULL SPECIFICATIONS. ALL QUANTITIES, MANUFACTURER, ALL TRADE DRESS SHOP DRAWINGS TO BE SUBMITTED TO DEVELOPMENT®			
ITEM NO.	QTY.	FURNITURE DESCRIPTION	MANUFACTURER	MODEL NO.	REMARKS
1001	1	PREP TABLE W/ PAN SLIDES FOR 48" GRIDDLE	CUSTOM STAINLESS		CONFIRM HEIGHT, WITH GRIDDLE MATCHES OTHER GRIDDLE.
1011	1	ONE-SIDED ISLAND OR WALL MOUNT 126" LONG (QTY2-CNH18LP, QTY1- CNH12LP)	CUSTOM STAINLESS	DETAIL A9.2	ENSURE LATEST DESIGN/SPEC FROM DEVELOPMENT@HUEYMAGOOS.COM IS USED
1032	1	9'-2" SELF SERVE BEVERAGE STATION - STAINLESS WITH DOORS	CUSTOM STAINLESS	STANDARD SIZE. DETAIL A9.1 & A9.2	ENSURE LATEST DESIGN/SPEC FROM DEVELOPMENT@HUEYMAGOOS.COM IS USED
1040	1	TRASH CABINET - SEE DETAIL ON A9 SHEETS (CALLOUT ON PLAN) ONE TRASH CHUTE	CUSTOM STAINLESS	DETAIL A9.1	ENSURE LATEST DESIGN/SPEC FROM DEVELOPMENT@HUEYMAGOOS.COM IS USED
1042	1	EXTERIOR TRASH CABINET POWDERCOATED METAL FRAME WITH FIBERON	CUSTOM STAINLESS	DETAIL A9.2	ENSURE LATEST DESIGN/SPEC FROM DEVELOPMENT@HUEYMAGOOS.COM IS USED

	TRADE DRESS SCHEDULE -										
		SEE FINISH SCHEDULE ON A6.1 FOR FULL SPECIFICATIONS. ALL QUANTITIES, MANUFACTURER, AND MODEL ALL TRADE DRESS SHOP DRAWINGS TO BE SUBMITTED TO DEVELOPMENT@HUEYMAGOOS.C									
ITEM NO.	QTY.	FURNITURE DESCRIPTION	MANUFACTURER	MODEL NO.	REMARKS						
2000	1	CUSTOM WOOD CHAIR RAIL MOUNTED AT 2'-8" AFF (INSTALLATION BY G.C.)	TRADEDRESS PROVIDER								
2001	1	CUSTOM COOKIE PIPE SHELVING	TRADEDRESS PROVIDER	CUSTOM	DETAIL ON A9.0						
2002	1	MERCHANDISING PANEL — IF TV AND MOUNT SPEC DIFFER FROM WHAT IS ON EQUIPMENT SCHEDULE, THE OPENING IN PANEL WILL NOT BE SIZED CORRECTLY.	TRADEDRESS PROVIDER								
2003	1	TV AT MERCHANDISING WALL	TRADEDRESS PROVIDER								
2004	1	MOUNT FOR TV AT MERCHANDISING WALL	TRADEDRESS PROVIDER								
2006	1	RED PICKUP SHELVES	TRADEDRESS PROVIDER								
2007	3	QUEUE RAIL — REFER TO PLAN FOR SIZES	TRADEDRESS PROVIDER								
2009	1	RECLAIMED BARNWOOD PLANKING - SEE FINISH SCHEDULE RBP-1 FOR SPEC. MIX 3IN/5IN PLANKS 50/50%. MIX BROWN/GRAY 66/33%.	TRADEDRESS PROVIDER								
2010	1	COMMUNITY TABLE BASE; SIZE TO MATCH COMMUNITY TABLE TOP	TRADEDRESS PROVIDER								

MILLWORK SCHEDULE (									
			SEE FINISH SCHEDULE ON A6.1 FOR FULL SPECIFICATIONS. ALL QUANTITIES, MANUFACTUR	RER, AND MODEL NO. TO BE VERIFIED WITH	OWNER PRIOR TO ORDERING.				
ITEM NO.	QTY.	,	FURNITURE DESCRIPTION	MANUFACTURER	MODEL NO.	REMARKS			
4001	1		FRONT COUNTER AND CASEWORK — SEE DETAIL ON A9.2 SHEET	MILLWORK PROVIDER		MILLWORK			
4002	1		BACK COUNTER AND CASEWORK — SEE DETAIL ON A9.2 SHEET	MILLWORK PROVIDER		MILLWORK			
4013	2		BANQUETTE BENCH (5'-6" WIDE)	MILLWORK PROVIDER	SEE DETAIL ON A9.0 SHEET	LOCATION INDOOR - BQ-1			

GRAPHICS SCHEDULE - BY GRAPHICS SERVICES SERVICES  SEE FINISH SCHEDULE ON A6.1 FOR FULL SPECIFICATIONS. ALL QUANTITIES, MANUFACTURER, AND MODEL NO. TO BE VERIFIED WITH OWNER PRIOR TO ORDERING.  ALL GRAPHICS SHOP DRAWINGS TO BE SUBMITTED TO DEVELOPMENT®HUEYMAGOOS.COM TO MAINTAIN BRAND CONSISTENCY								
ITEM NO.	QTY.	FURNITURE DESCRIPTION	MANUFACTURER	MODEL NO.	REMARKS			
3000	1	SOFFIT DECAL CRAFT IT CRAVE IT RAVE IT	INT. GRAPHICS PROVIDER	SEE DETAIL ON SHEET A9.1				
3007	1	RESTROOM BANNER	INT. GRAPHICS PROVIDER	SEE DETAIL ON SHEET A9.1				
3008	1	ORDER HERE BANNER	INT. GRAPHICS PROVIDER	SEE DETAIL ON SHEET A9.1				
3009	2	GUYS AND GALS RESTROOM DOOR DECALS	INT. GRAPHICS PROVIDER					
3011	1	FILET MIGNON	INT. GRAPHICS PROVIDER					
3012	1	INTERIOR G LOGO SIGN — ACRYLIC	INT. GRAPHICS PROVIDER					
3014	1	ILLUMINATED PICKUP SIGN	INT. GRAPHICS PROVIDER	SEE DETAIL ON SHEET A9.1	PROVIDE POWER AT SOFFIT ABOVE PICKUP COUNTER			
3015	1	TEAS AND SODA SIGN	INT. GRAPHICS PROVIDER	SEE DETAIL ON SHEET A9.1	ATTACH TO DECK OR TRUSS AS ALLOWED BY JURISDICITON			
3016	1	MAKE SOMEONE SMILE TODAY - BARNWOOD SIGN	INT. GRAPHICS PROVIDER	SEE DETAIL ON SHEET A9.0	SEE BARNWOOD SPEC FROM TRADE DRESS AND FINISH SCHEDULE RBP-1			
3021	1	DIGITAL MENU BOARD — ADD ITEM 5080 MONITORS	INT. GRAPHICS PROVIDER	REQUEST DETAIL	CONFIRM MONITOR MODEL AND DRAWINGS WITH DEVELOPMENT@HUEYMAGOOS.COM			
3022	1	PAINTED LOGO – EST. ON BRICK WALL	INT. GRAPHICS PROVIDER	REQUEST DETAIL	ENSURE LATEST DESIGN/SPEC FROM DEVELOPMENT@HUEYMAGOOS.COM IS USED NO LOGO W/ USB			

INTERPLAN INTERPLAN LLC

ARCHITECTURE ENGINEERING PERMITTING

220 E. CENTRAL PKWY, STE 4000 ALTAMONTE SPRINGS, FL 32701 407.645.5008

THIS DOCUMENT IS NOT FOR REGULATORY APPROVAL, PERMITTING, OR CONSTRUCTION.

License #: \_\_\_\_\_\_
Expiration Date: \_\_\_\_\_

no date remarks REVISIONS



HUEY MAGOO'S WORTHINGTON

WORTHINGTON GATEWAY 53 W. WILSON BRIDGE ROAD WORTHINGTON, OH 43085

PROJECT NO: 2022.0800 DATE: 08/09/23

CITY OF WORTHINGTON DRAWING NO. ARB 0072-2023 DATE 08/29/2023 A7.0

URNITURE MILLWORK TRADE

FURNITURE MILLWORK TRADE DRESS PLAN

CHECKED: JMA DRAWN: BW









# MPC APPLICATION ADP 09-2023 6670 Huntley Rd.

Plan Type: Amendment to Development Plan

Project:

App Date:

08/24/2023

Work Class: Amendment to Development Plan

In Review

District:

City of Worthington

Exp Date:

Completed:

**Approval** 

Valuation: \$0.00

Status:

Expire Date:

**Description:** This variance request it for additional signage square footage. The signage needed for this building

is finally coming to scale and hasn't changed from its conceptual appearance that Council has previously approved. The total signage square footage needed is 246 square feet. We are asking for a variance to allow the additional 146 square feet that brings our conceptual plan to life.

Parcel: 100-002184

Main

Address: 6670 Huntley Rd

Main

Zone: I-1(Restricted Industrial: Research Office

Worthington, OH 43229

Applicant / Owner Chris Tilton 6670 Huntley Rd Columbus, OH 43229

Business: (614) 547-0685 Mobile: (614) 315-2108

Invoice No.	Fee		Fee Amount	<b>Amount Paid</b>
INV-00004470	Amendment to Development Plan		\$50.00	\$50.00
		Total for Invoice INV-00004470	\$50.00	\$50.00
		Grand Total for Plan	\$50.00	\$50.00

# 6670 Huntley Rd.








### #S1-2268.23: HALO-LIT CHANNEL LOGO AND LETTERS WITH PVC SMALLER COPY

SCALE: 3/4'' = 1'-0''

- LOGO: 2" DEEP ROUTED HDU PAINTED PMS 187 RED.
- "TILTONS": 2" DEEP ROUTED HDU PAINTED WHITE ON ALL SURFACES. 3630-97 BRISTOL BLUE AND 3630-53 CARDINAL RED VINYL OVERLAYS ON THE LETTER FACES ONLY.
- ILLUMINATION: WHITE LED
- "AUTOMOTIVE SERVICE": (NON-ILLUMINATED) 3/4" THICK WHITE PVC, STUD MOUNTED FLUSH.



**NITE VIEW** 

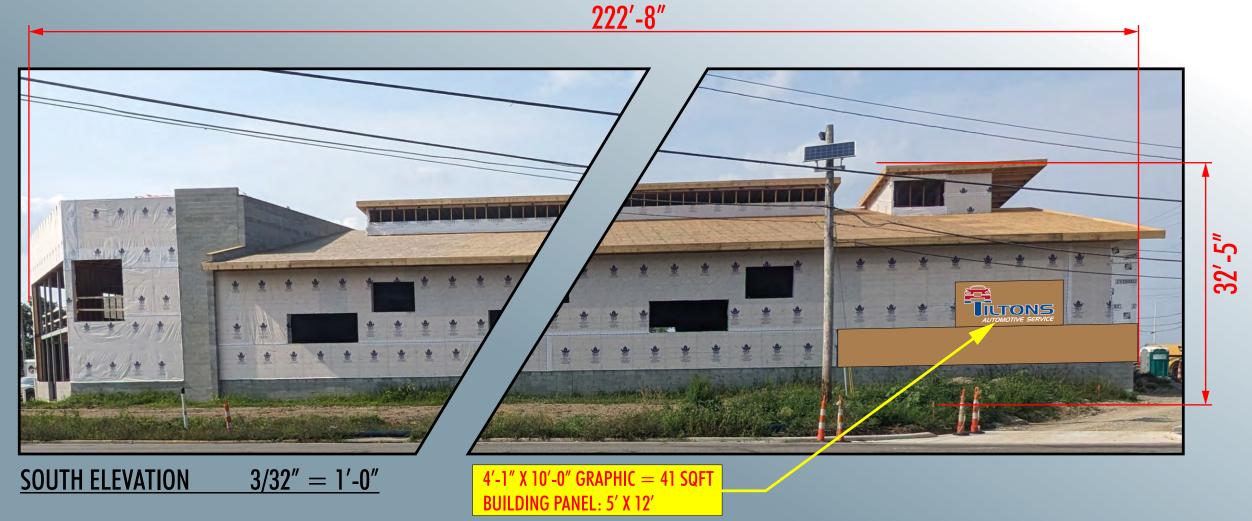





CITY OF WORTHINGTON DRAWING NO. ADP 09-2023 DATE 08/24/2023

#### COLORS

WHITE

3630-53 CARDINAL RED (PMS 187 RED)

3603-97 BRISTOL BLUE VINYL

APPROVED-CUSTOMER

Central Ohio

INTERNATIONAL
SIGN ASSOCIATION



**TILTONS AUTOMOTIVE** #S1-2268.23 6670 HUNTLEY RD. WORTHINGTON, OH

HALO-LIT WALL SIGNAGE

8/22/23 REV. DATE:

TILTONS AUTOMOTIVE.CDR DIRECTORY THAD > 2023 > T

SCALE AS NOTED SALE MF DESIGNER TK



### #S1-2268.23: HALO-LIT CHANNEL LOGO AND LETTERS WITH PVC SMALLER COPY

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NITE VIEW



3/32'' = 1'-0''**WEST ELEVATION** 

 $4'-1'' \times 10'-0'' GRAPHIC = 41 SQFT$ **BUILDING PANEL: 5' X 12'** 





CITY OF WORTHINGTON DRAWING NO. ADP 09-2023

#### COLORS

WHITE

3630-53 CARDINAL RED (PMS 187 RED)

3603-97 BRISTOL BLUE VINYL

APPROVED-CUSTOMER

Central Ohio

INTERNATIONAL
SIGN ASSOCIATION





**TILTONS AUTOMOTIVE** #S1-2268.23 6670 HUNTLEY RD. WORTHINGTON, OH

HALO-LIT WALL SIGNAGE

8/22/23 REV. DATE: TILTONS AUTOMOTIVE.CDR

THAD > 2023 > T


SCALE AS NOTED SALE MF DESIGNER TK

# 20'-6" 8′-0″

# #S2-2268.23: HALO-LIT CHANNEL LOGO


SCALE: 1/4'' = 1'-0''

- LOGO: 6" DEEP FABRICATED ALUMINUM PAINTED PMS 187 RED.
- ILLUMINATION: WHITE LED

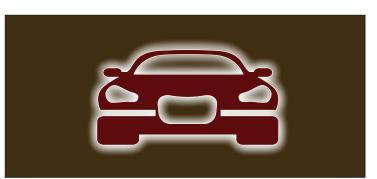

**NITE VIEW** 

98'-6"

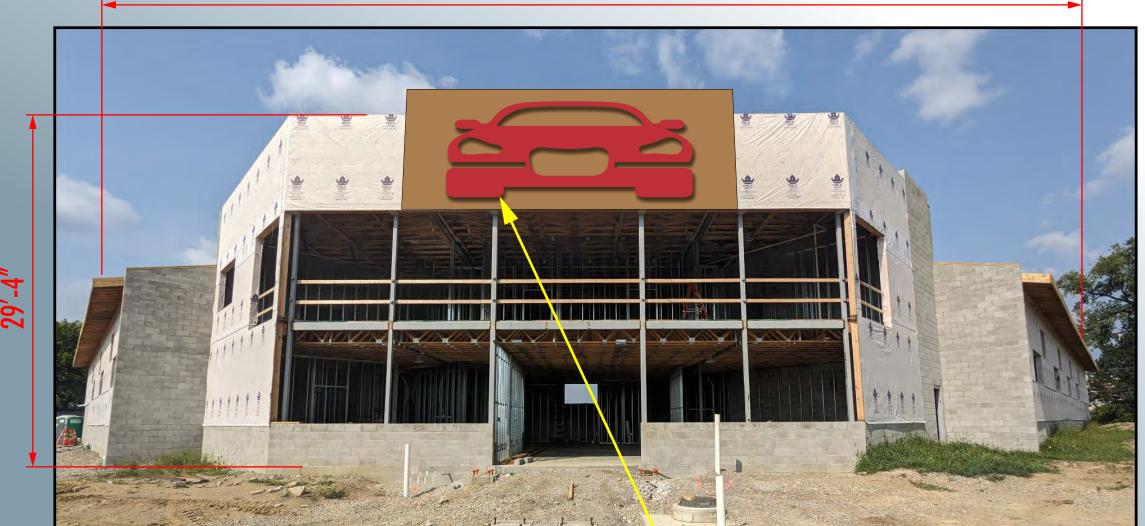

**SOUTH WEST ELEVATION** 

1/8'' = 1'-0''

 $8'-0'' \times 20'-6'' \text{ CAR} = 164 \text{ SQFT}$ **BUILDING PANEL: 10' X 28'** 





CITY OF WORTHINGTON DRAWING NO. ADP 09-2023 DATE 08/24/2023

#### COLORS

PMS 187 RED

APPROVED-CUSTOMER







#S2-2268.23

TILTONS AUTOMOTIVE STREET HALO-LIT WALL SIGNAGE

6670 HUNTLEY RD. WORTHINGTON, OH

DATE

REV. DATE: 8/22/23 TILTONS AUTOMOTIVE.CDR

DIRECTORY THAD > 2023 > T

SCAUE AS NOTED SAUE MF DESIGNER TK